



# Town of Kensington Development Review Board




10509 Summit Avenue The Flats at Knowles Stations Courtesy of Woodside Development August 24, 2020 7pm

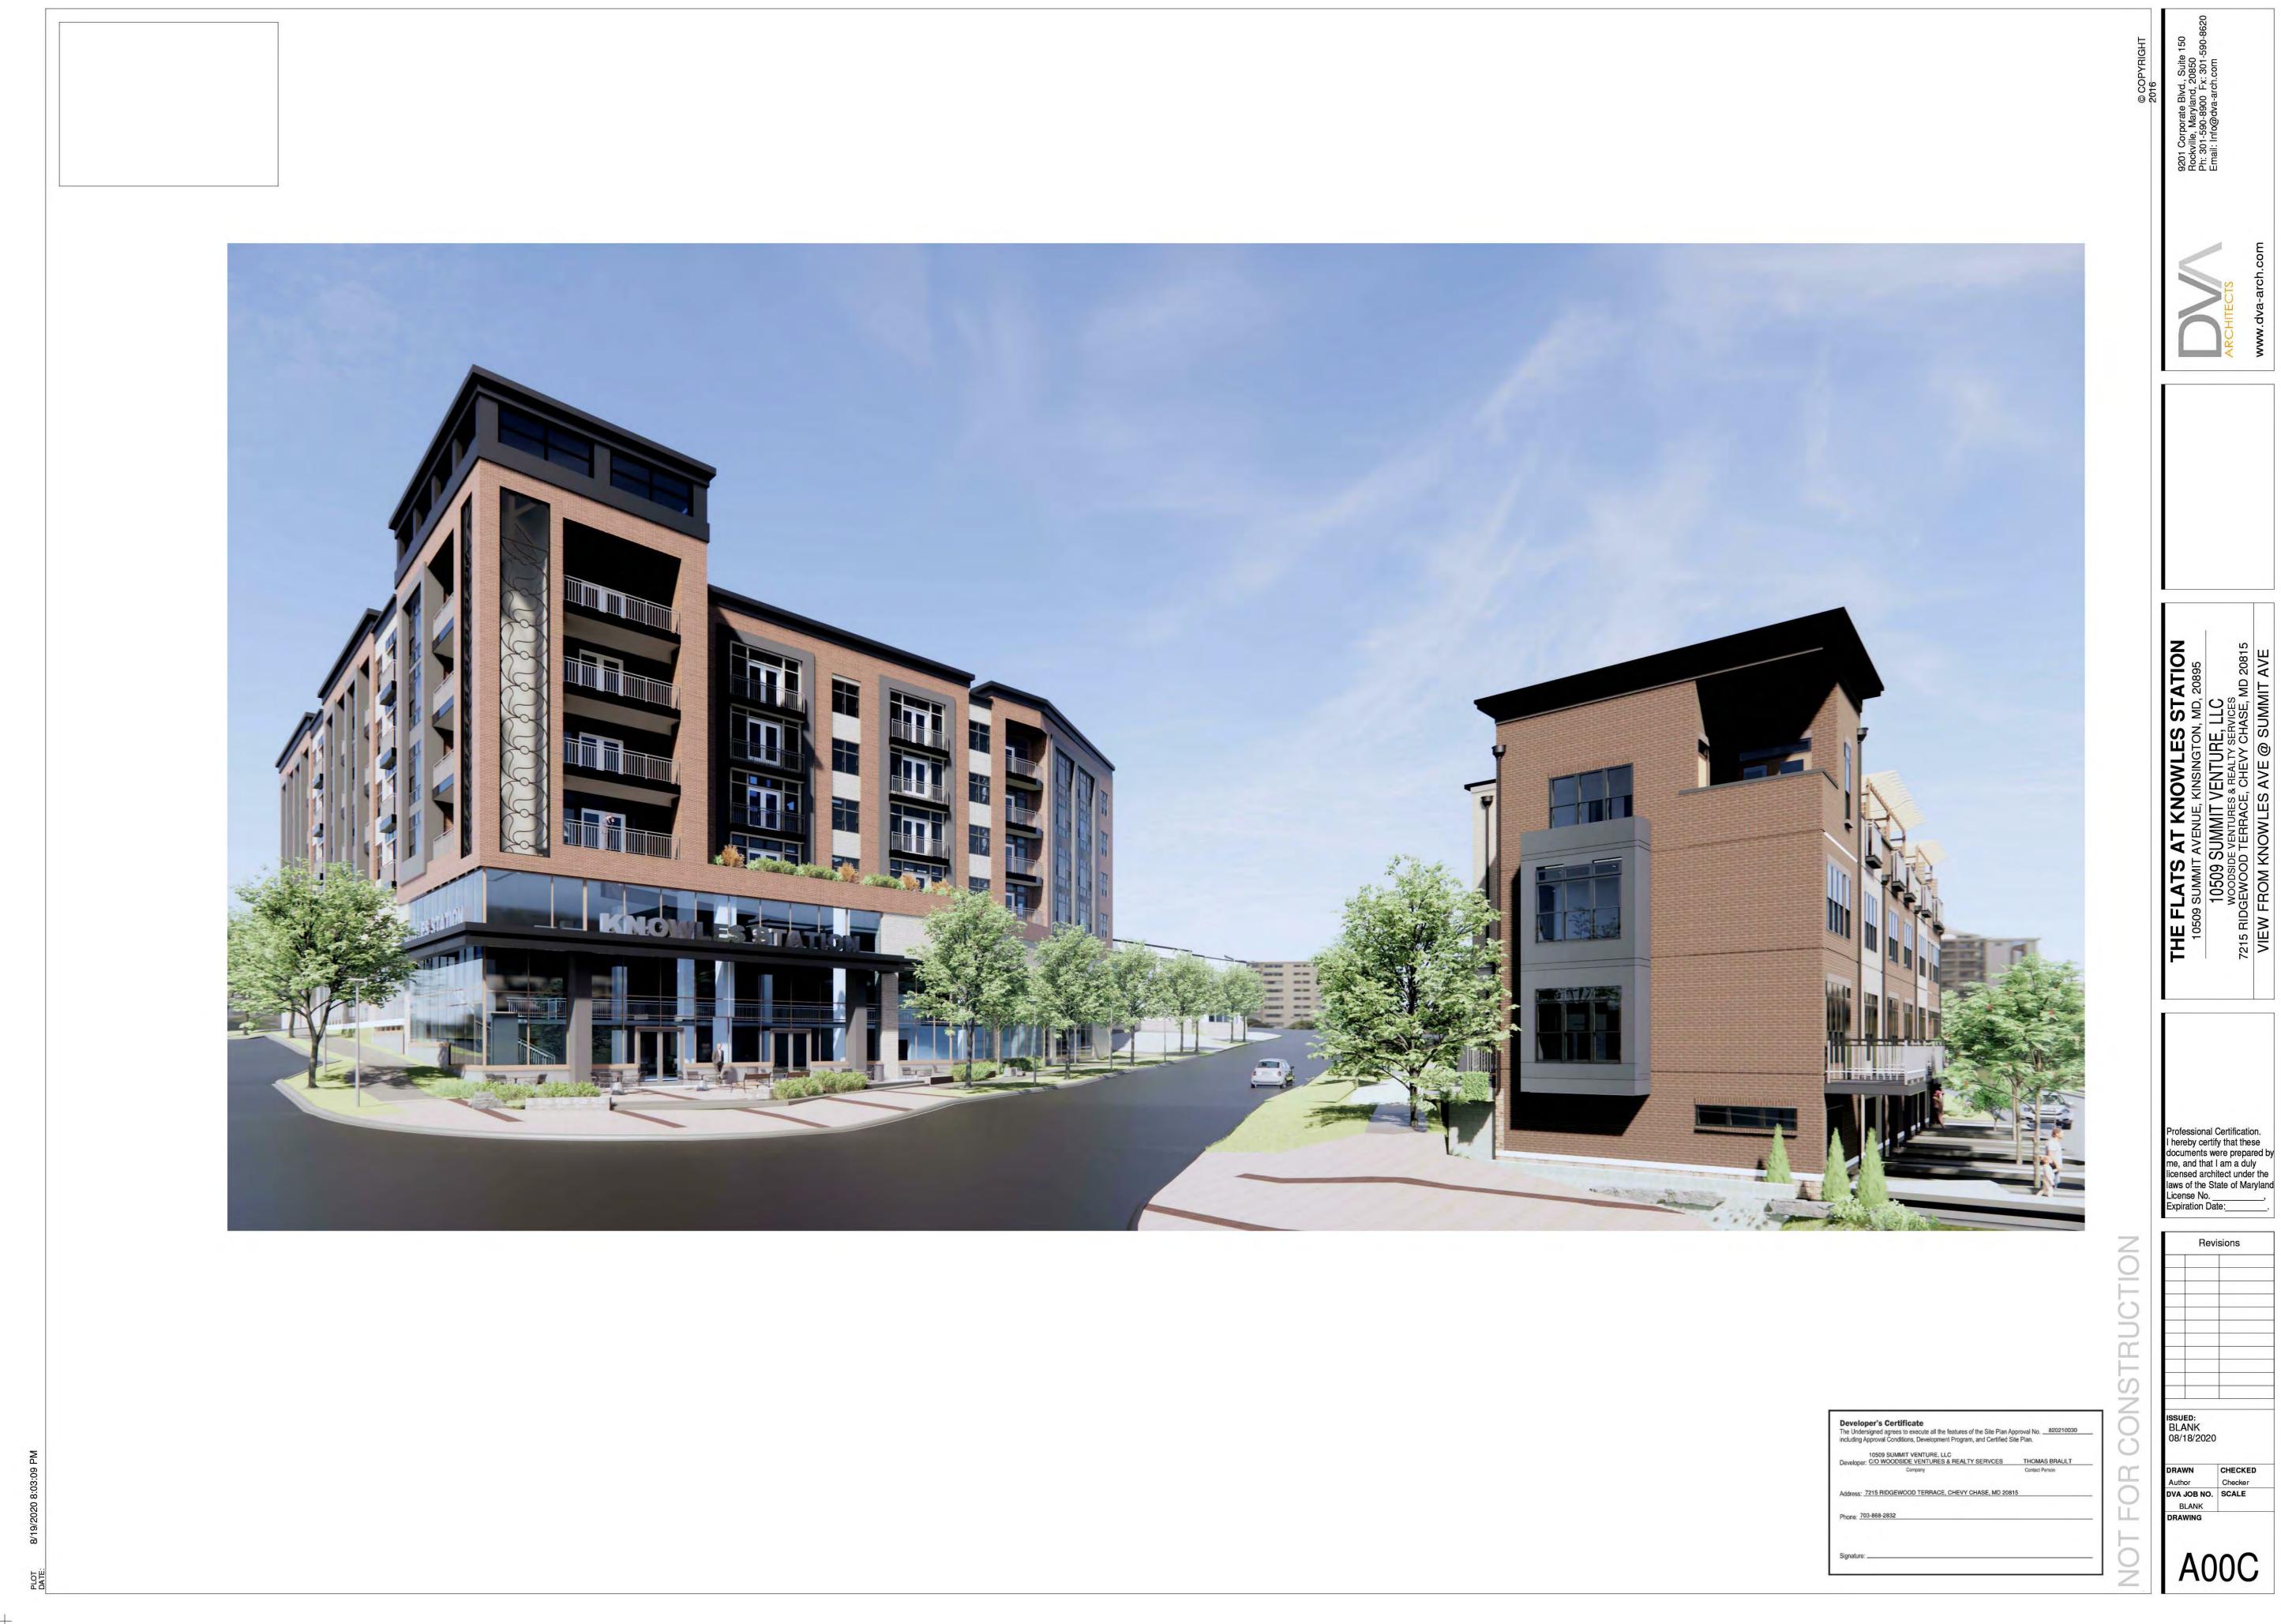




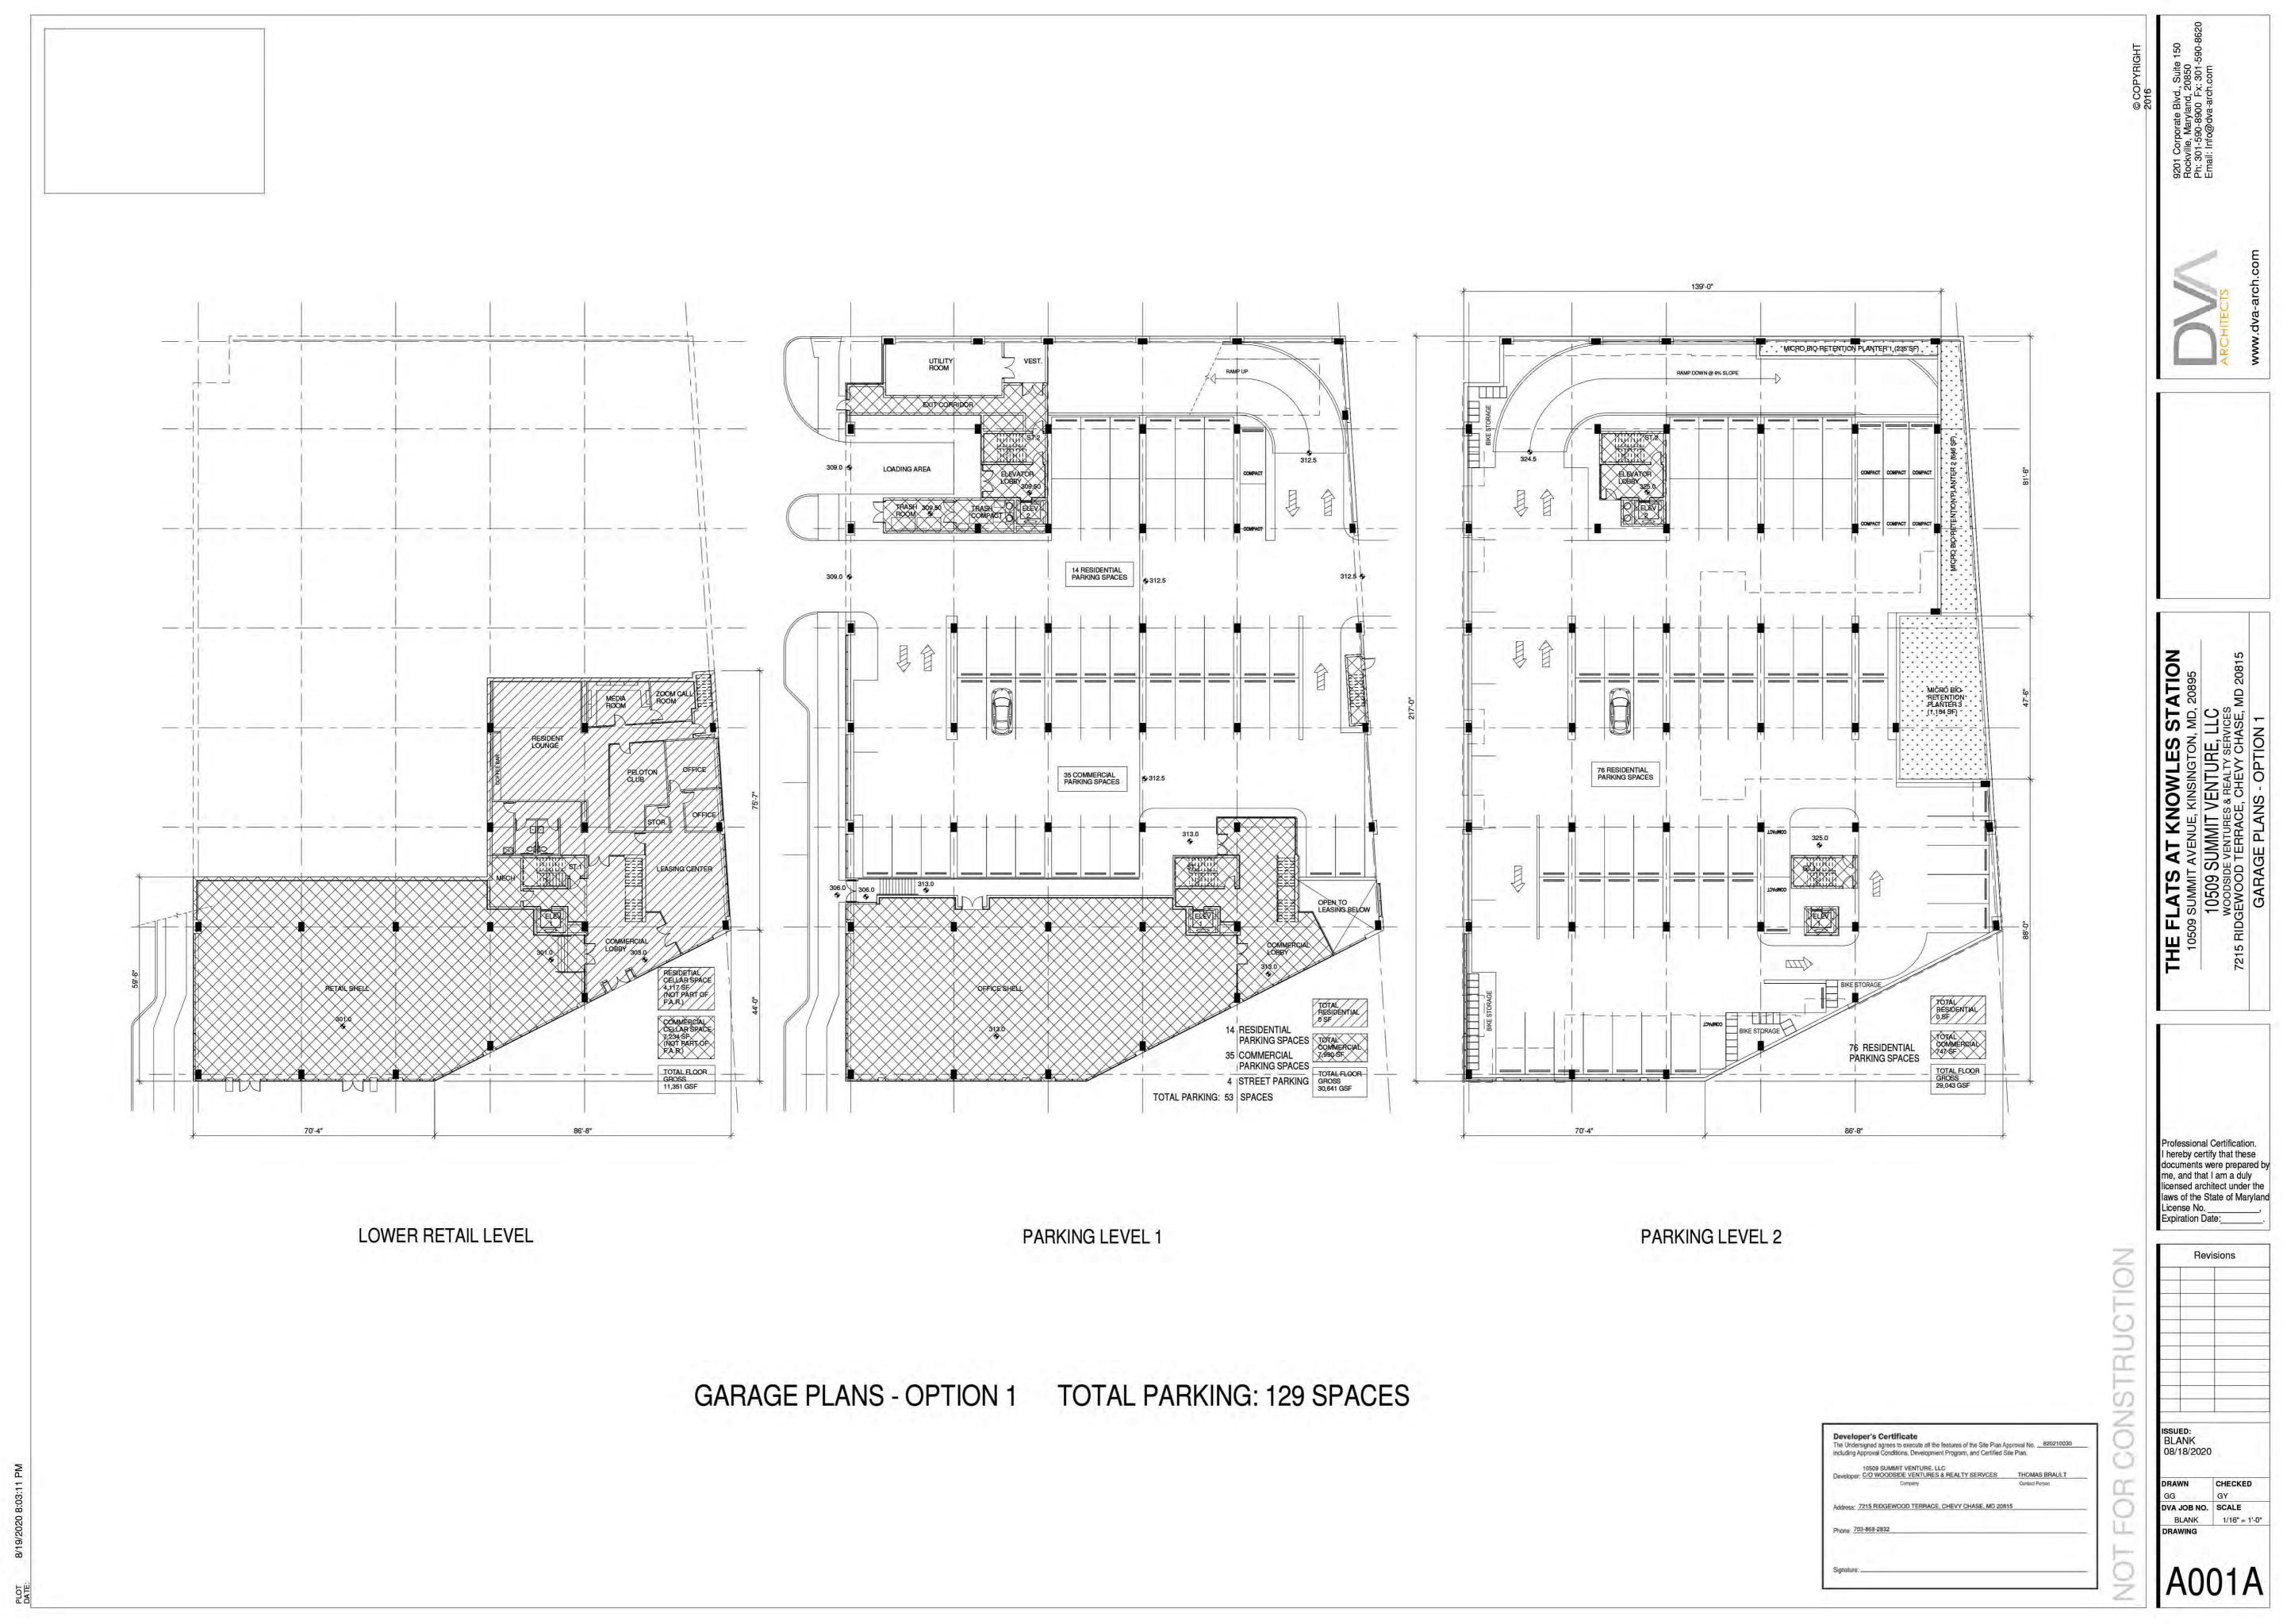

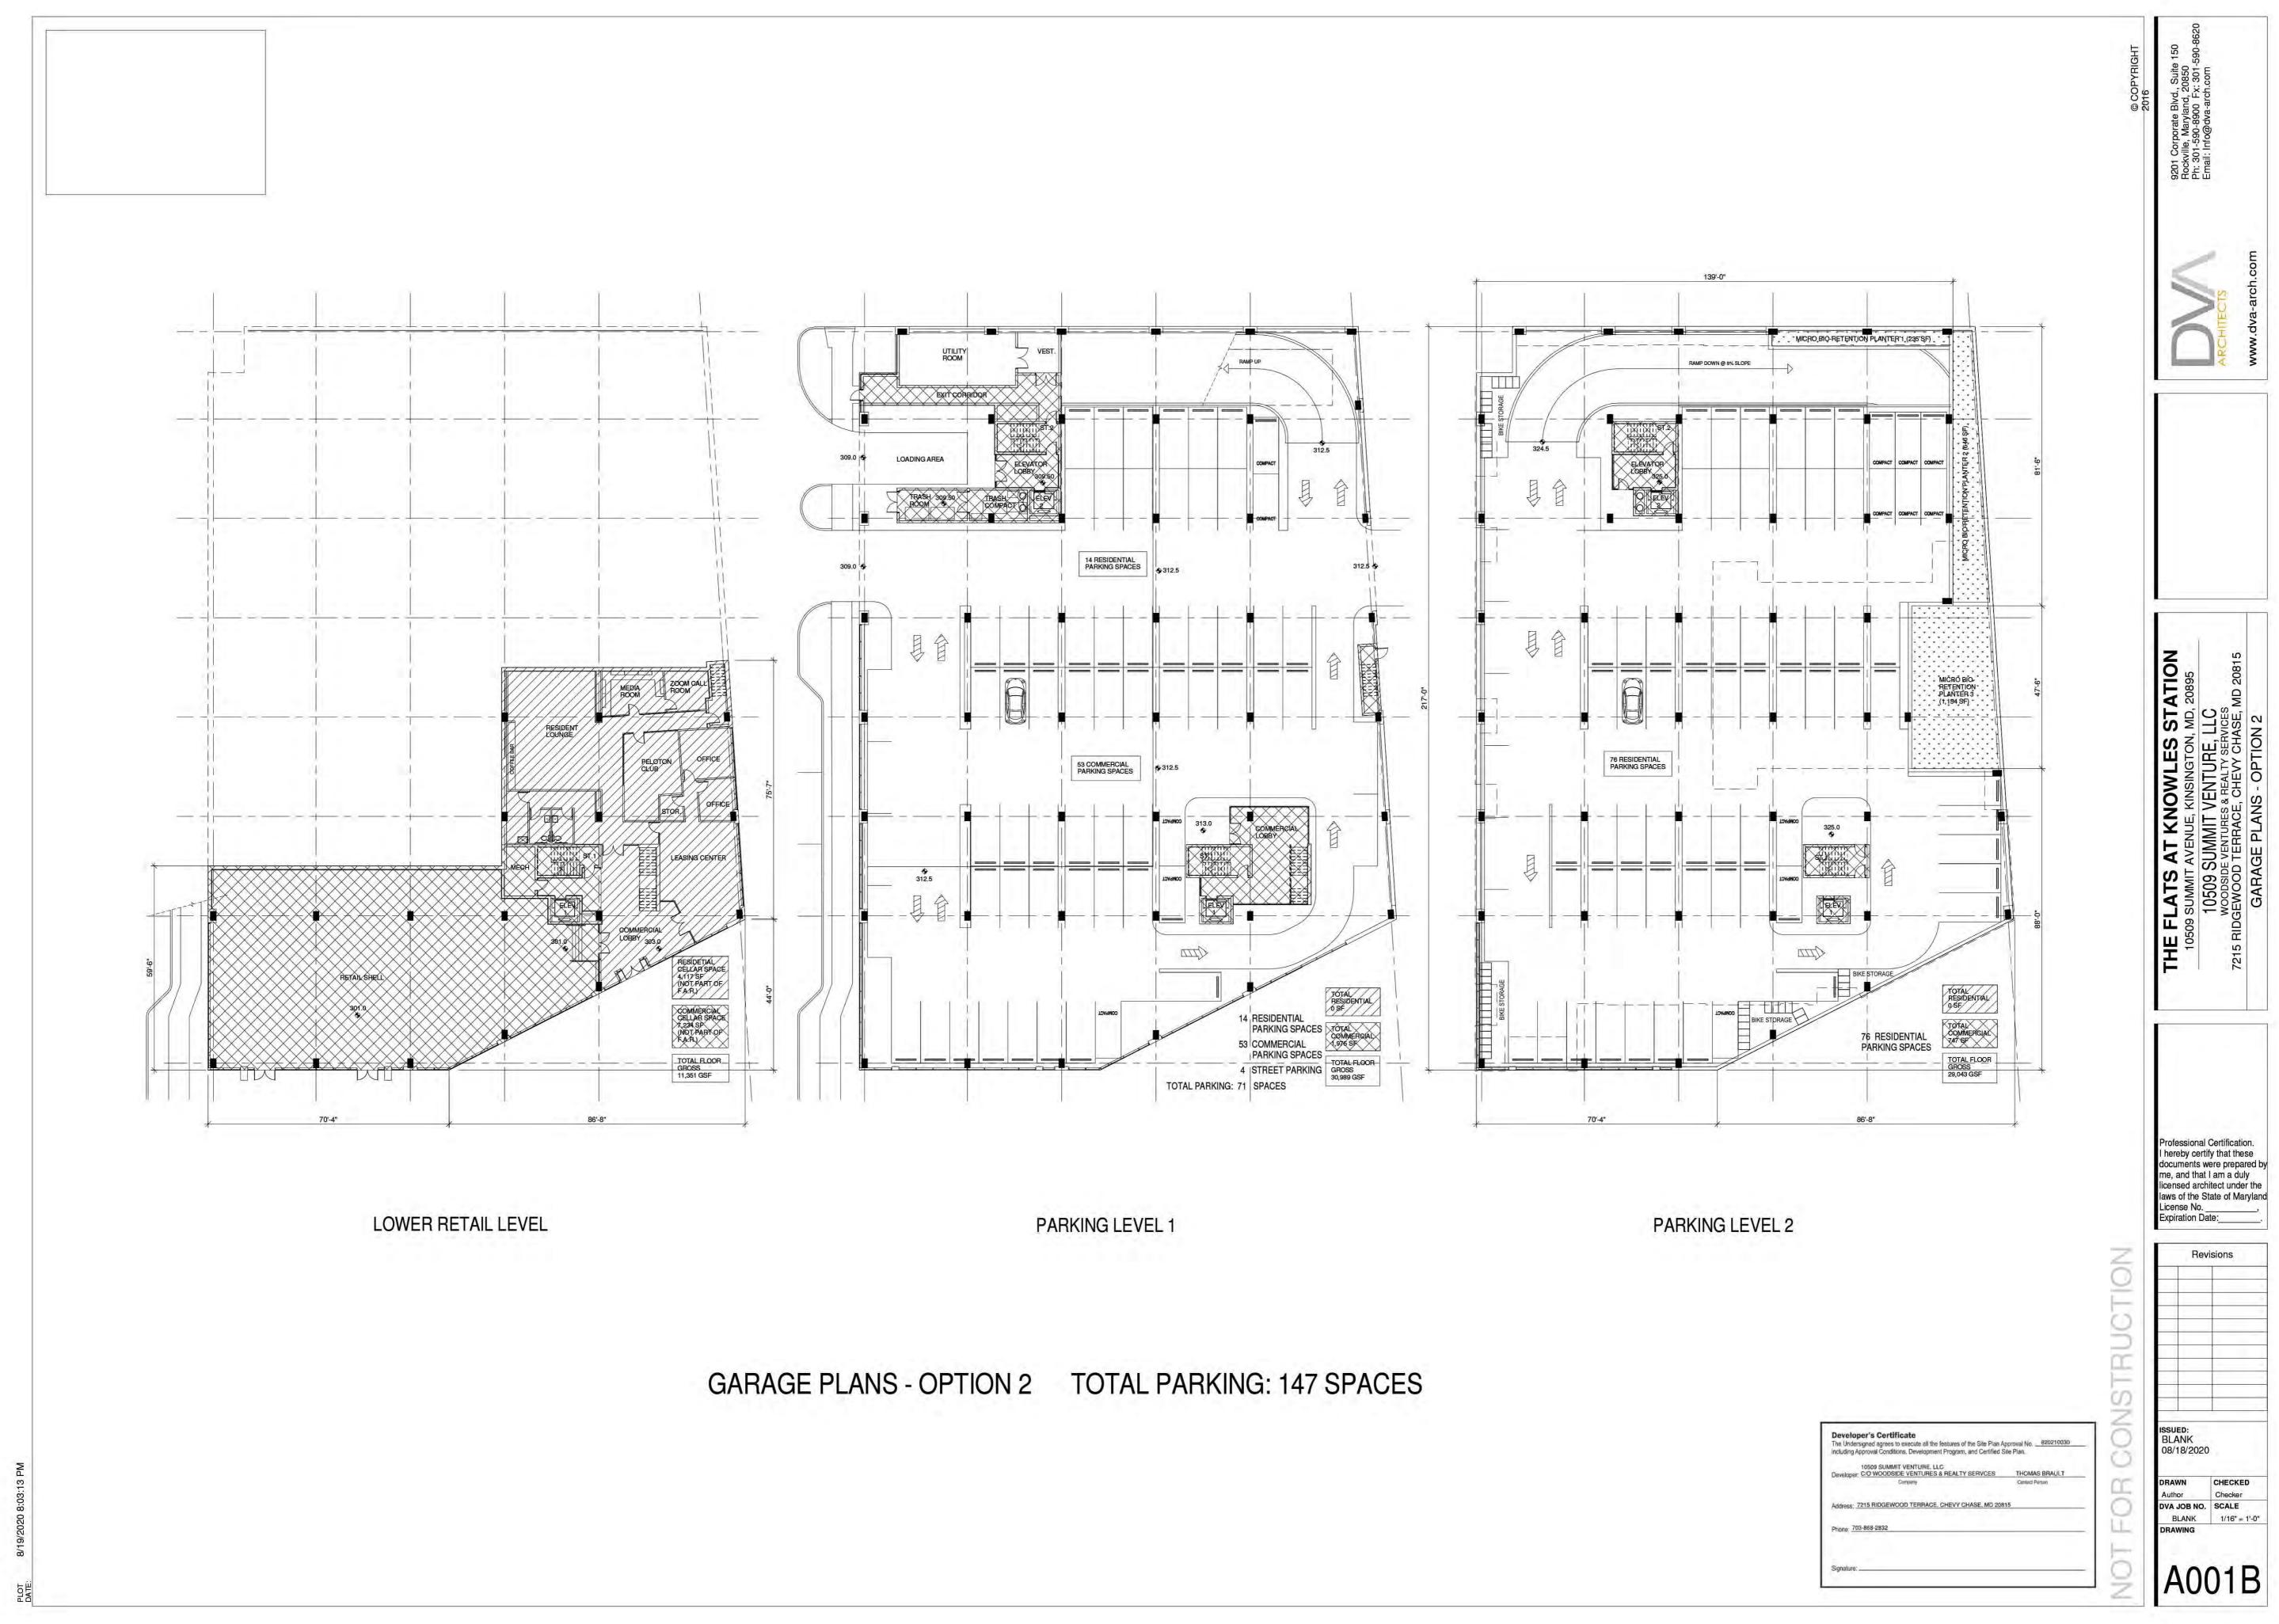






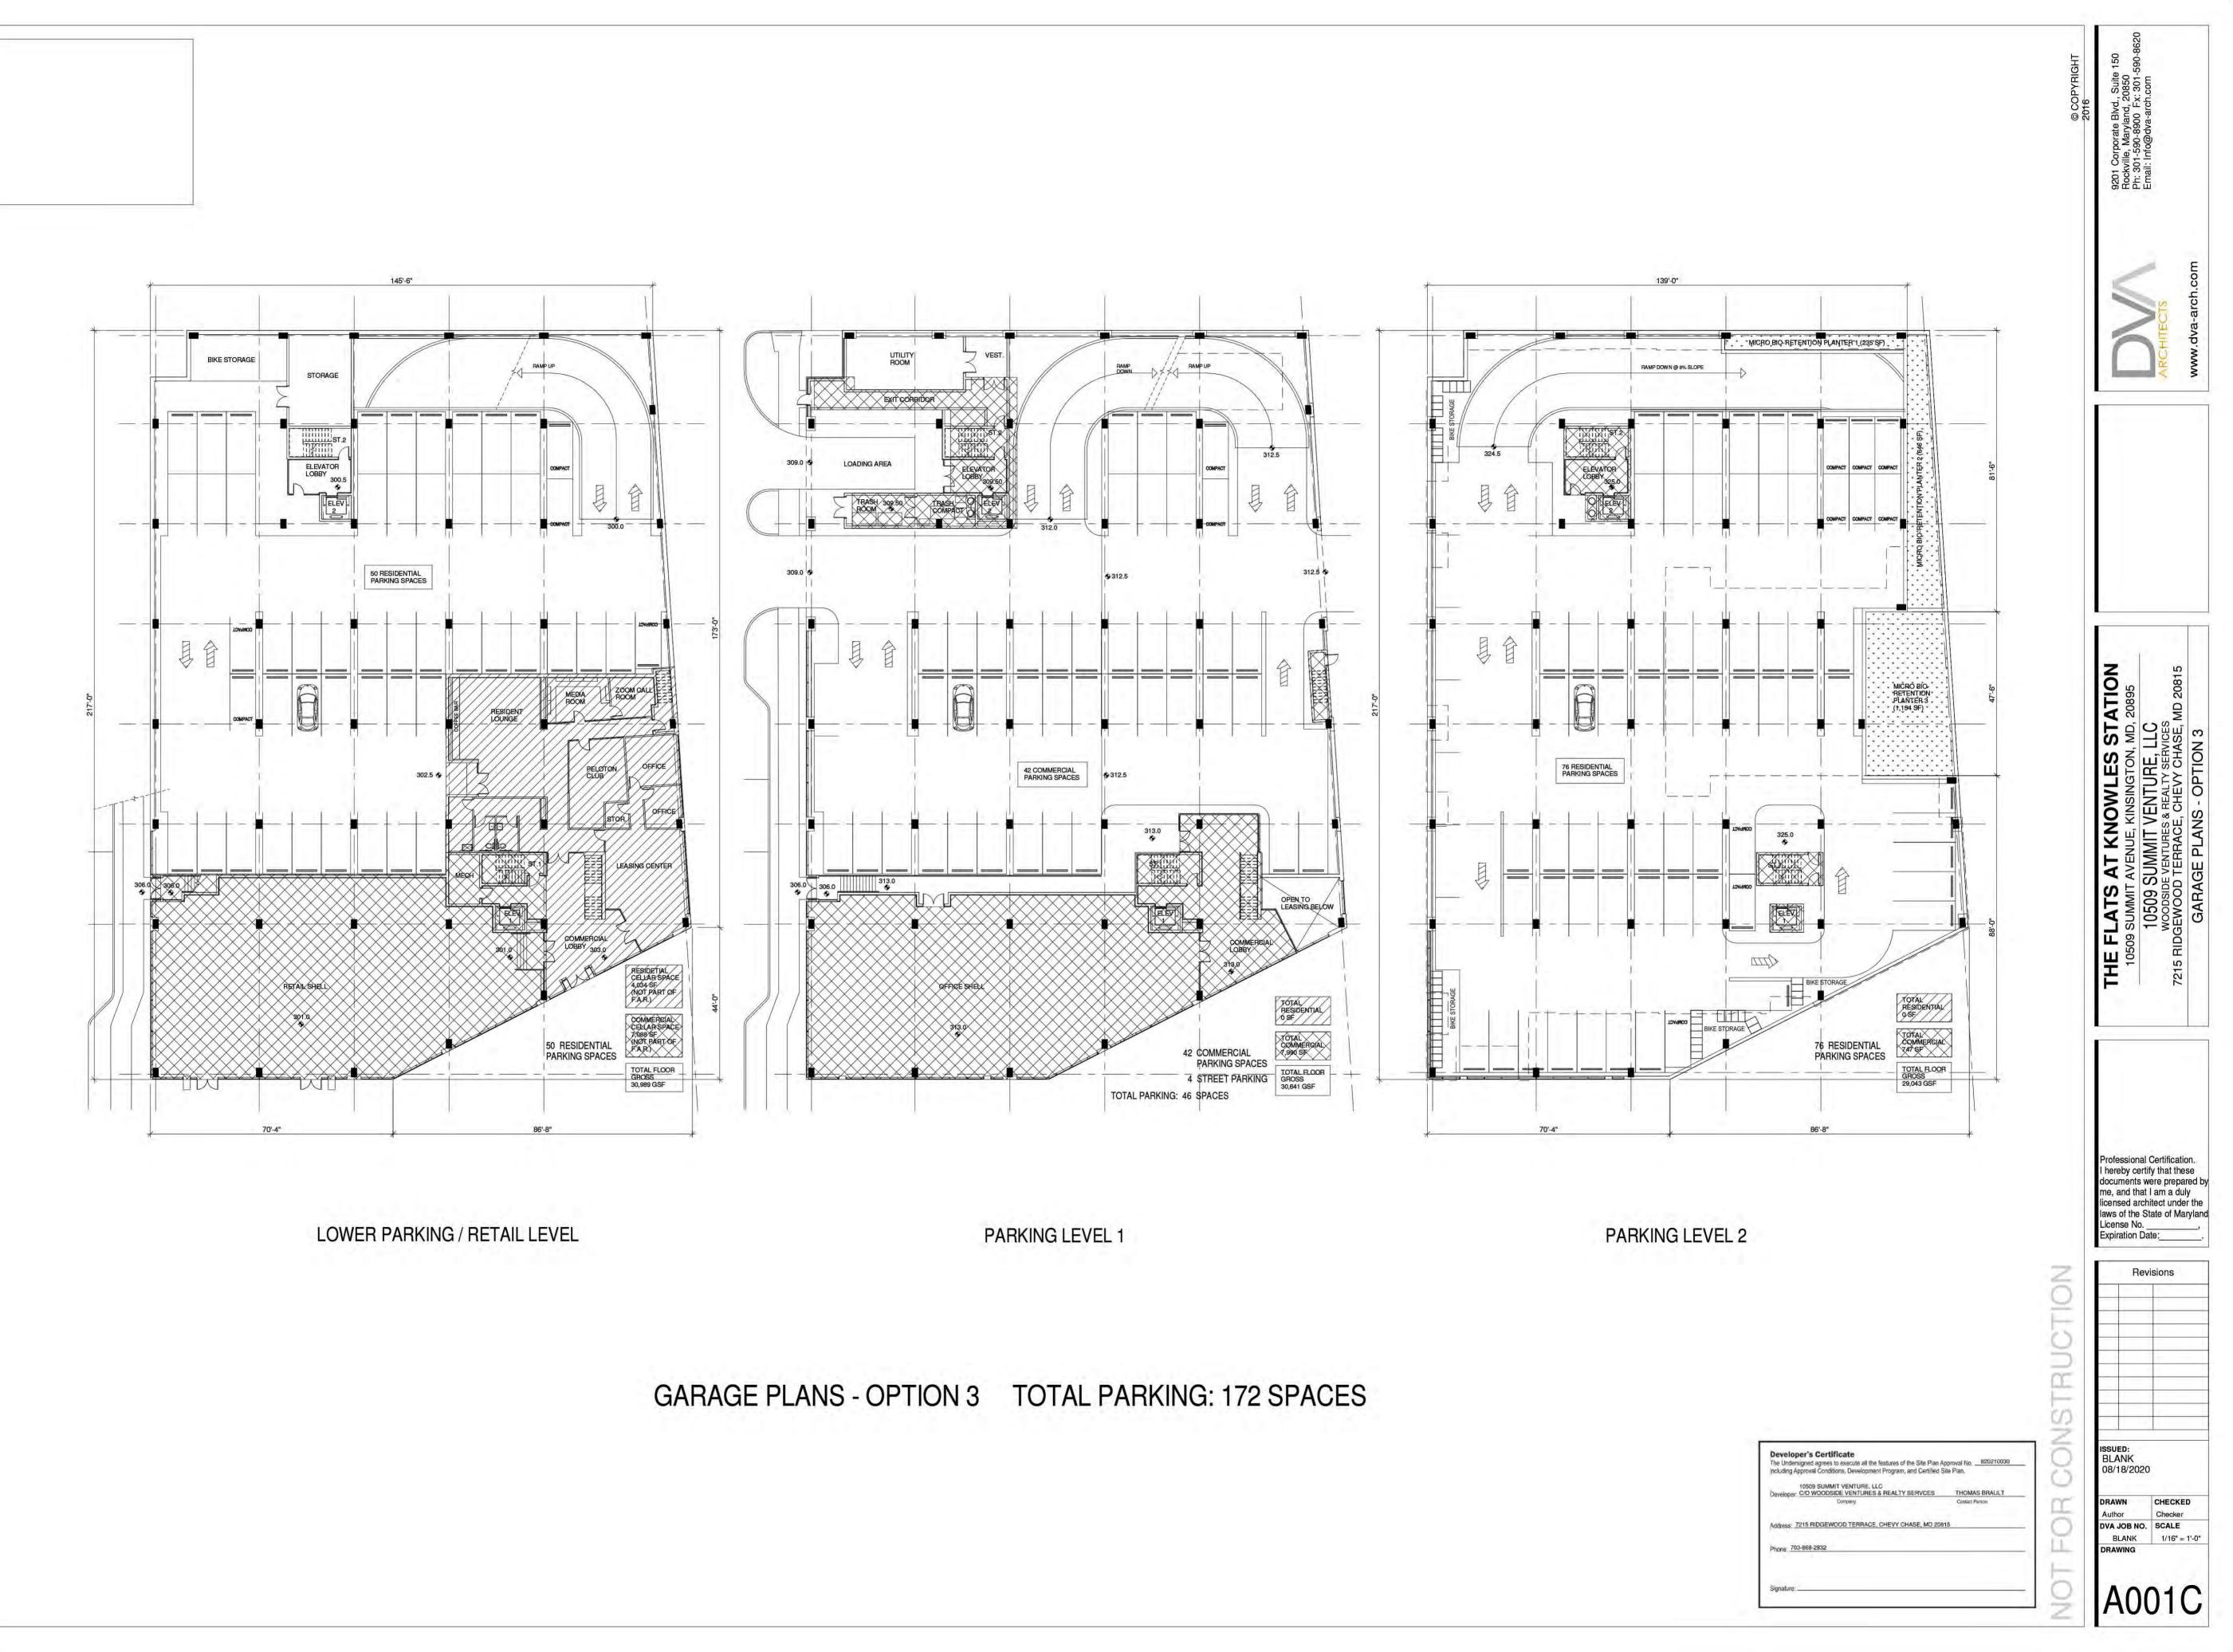



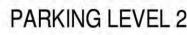







### 139'-0" WWW-W N N STUDIO 660 sf STUDIO 577 sf 2 BEDRM/DEN 2 BEDRM /DEN 1 BEDRM 1314 sf 800 sf 1156 sf ST 2 CORRIDOR 1587 SF TRASE ELEVZ. 98 STO 66 SF STUDIO 584 sf 1 BEDRM 803 sf 2 BEDRM 926 sf 1 BEDRM 745 sf STUDIO 590 sf 1 BEDRM 810 sf 1 BEDRM 800 sf 1 BEDRM 745 sf 1 BEDRM 800 sf FW-W 1 BEDRM 745 sf - 9 x 6 STUDIO 656 sf STUDIO 682 sf 1 BEDRM 698 sf 1 BEDRM 741 sf TUTUTUST 1 2 BEDHM 965 sf 423 SF 1 BEDRM 810 sf ELEVI 66 SF 2 BEDRM 921 sf 2 BEDRM /DEN 1392sf 1 BEDRM/DEN 1012 sf 1 BEDRM/DEN 957sf KENSINGTON OVERLOOK TOTAL RESIDENTIAL 22,738 SF TOTAL COMMERCIAL 464 SF 6 2-BEDROOM UNITS 13 1-BEDROOM UNITS 6 STUDIO UNITS TOTAL : 25 RESIDENTIAL UNITS 29'-8"


**RESIDENTIAL LEVEL 2 THRU LEVEL 4** 

# TOTAL RESIDENTIAL UNIT: 100 UNITS

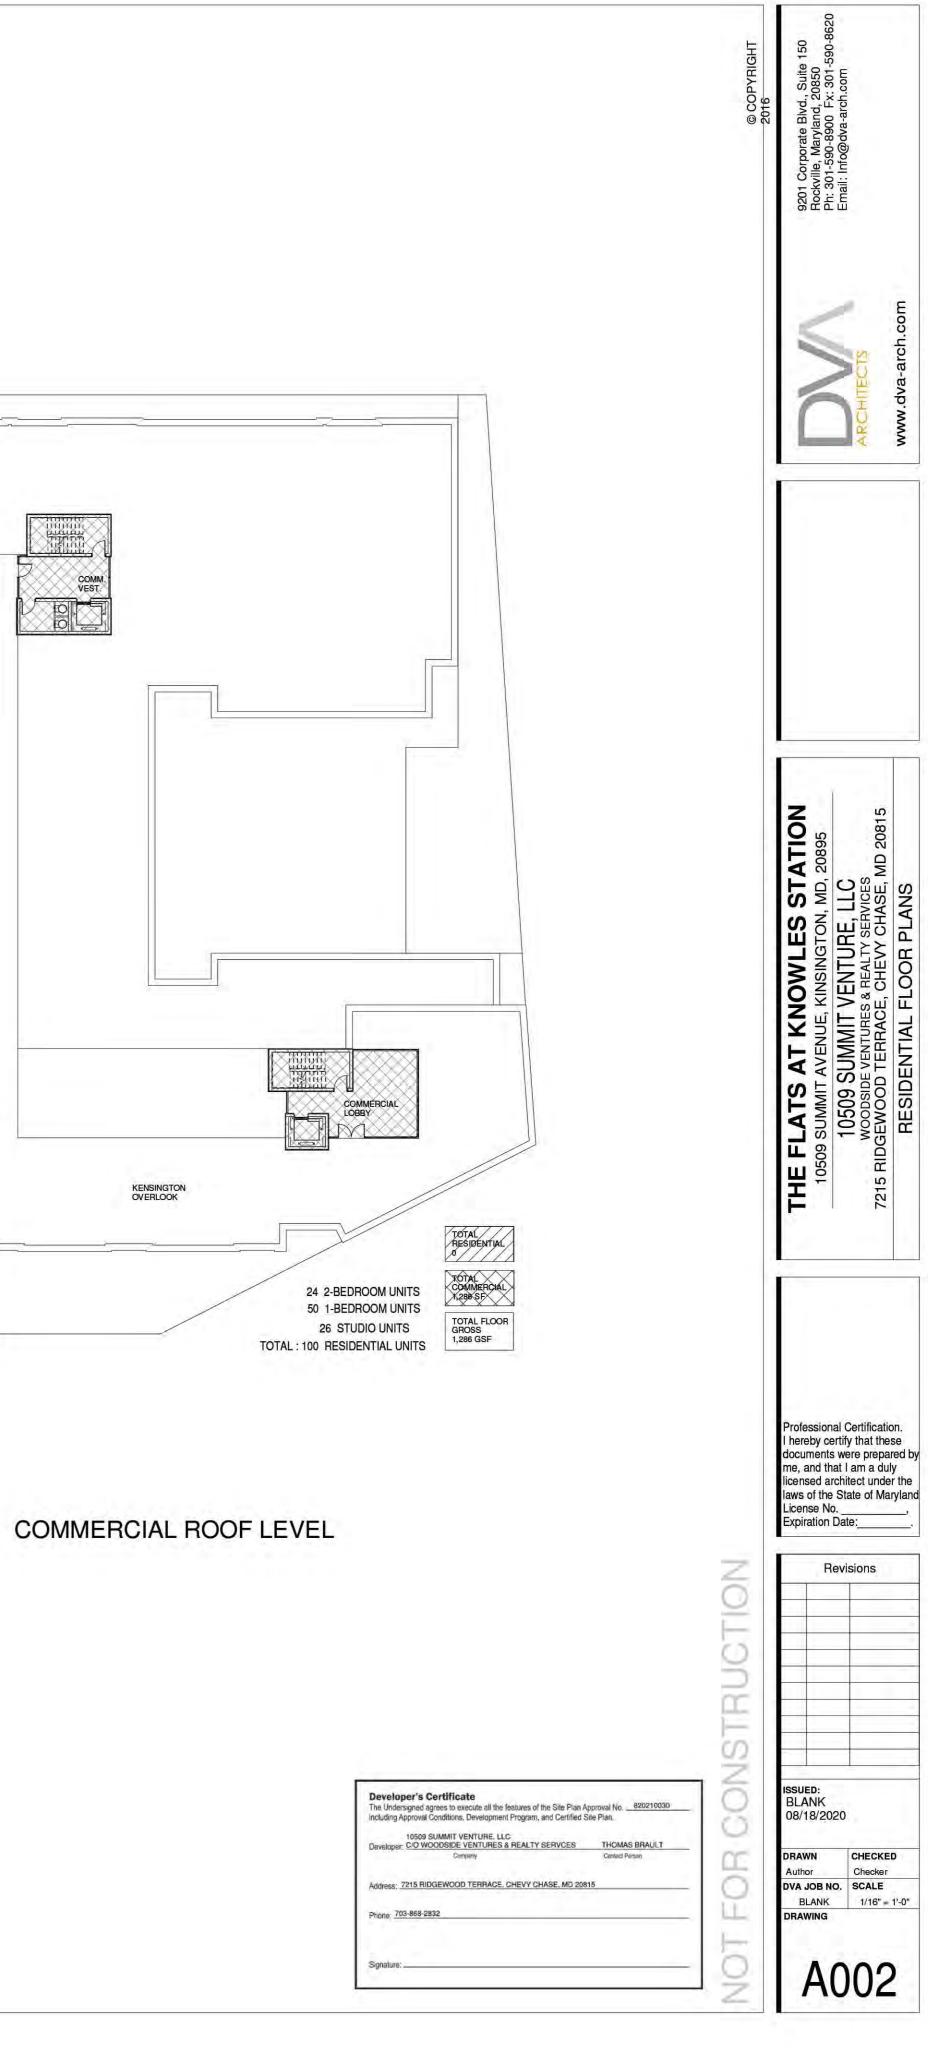



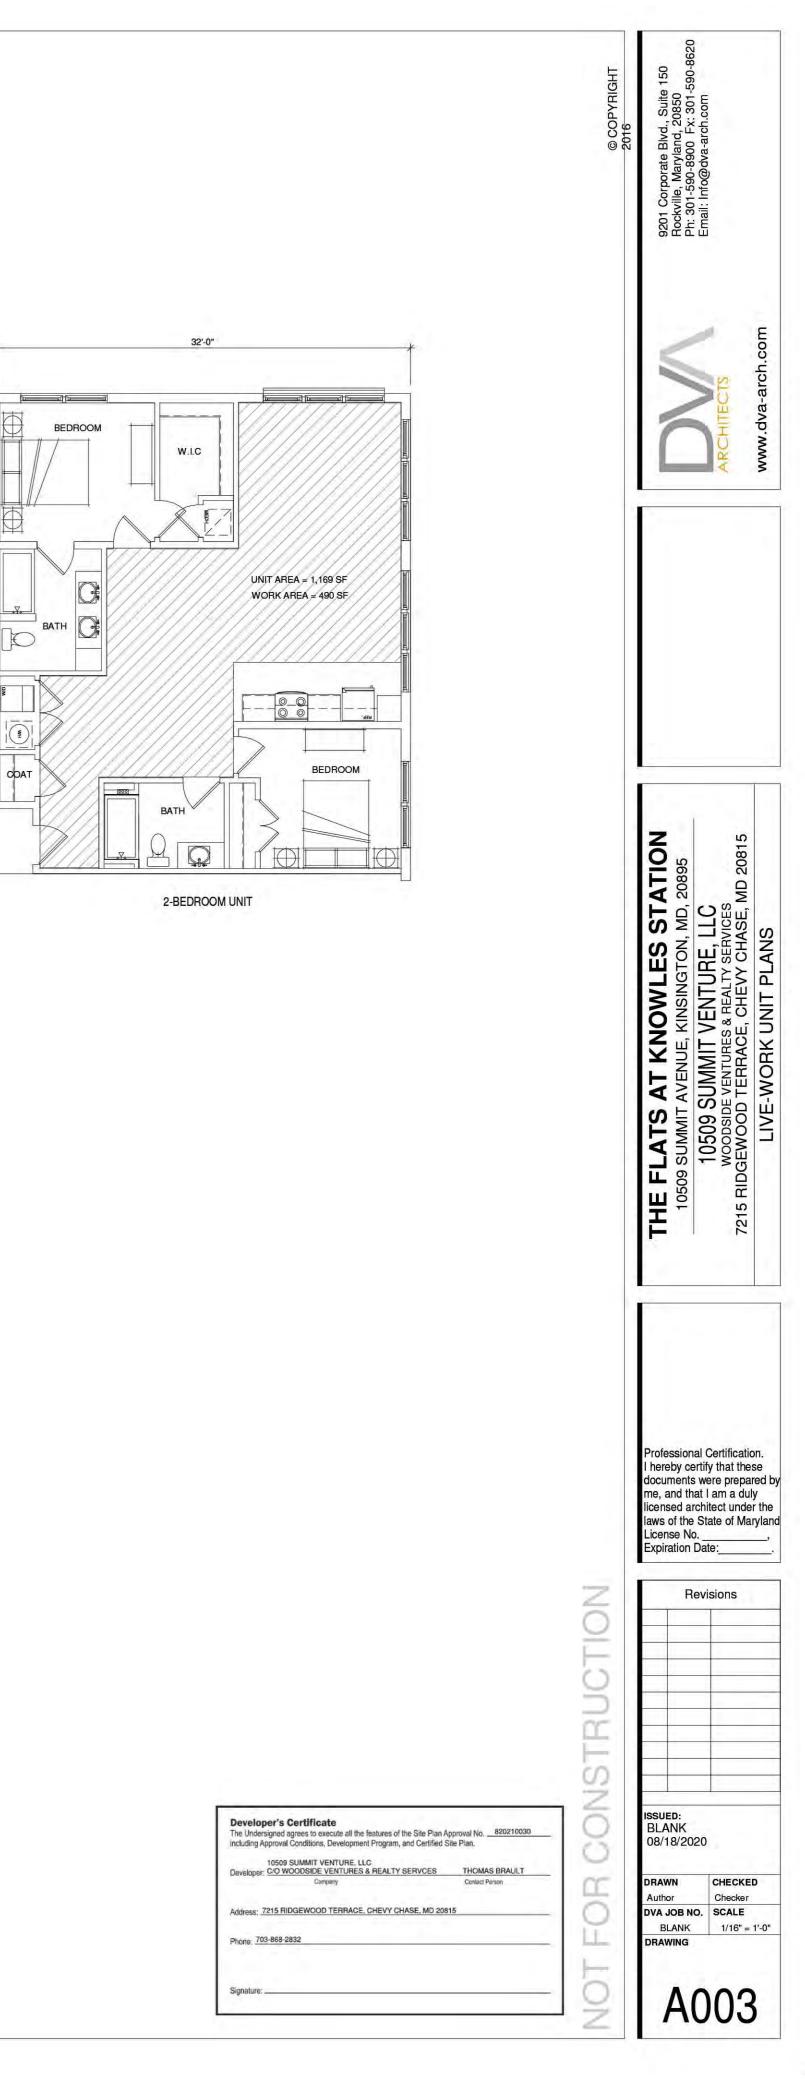

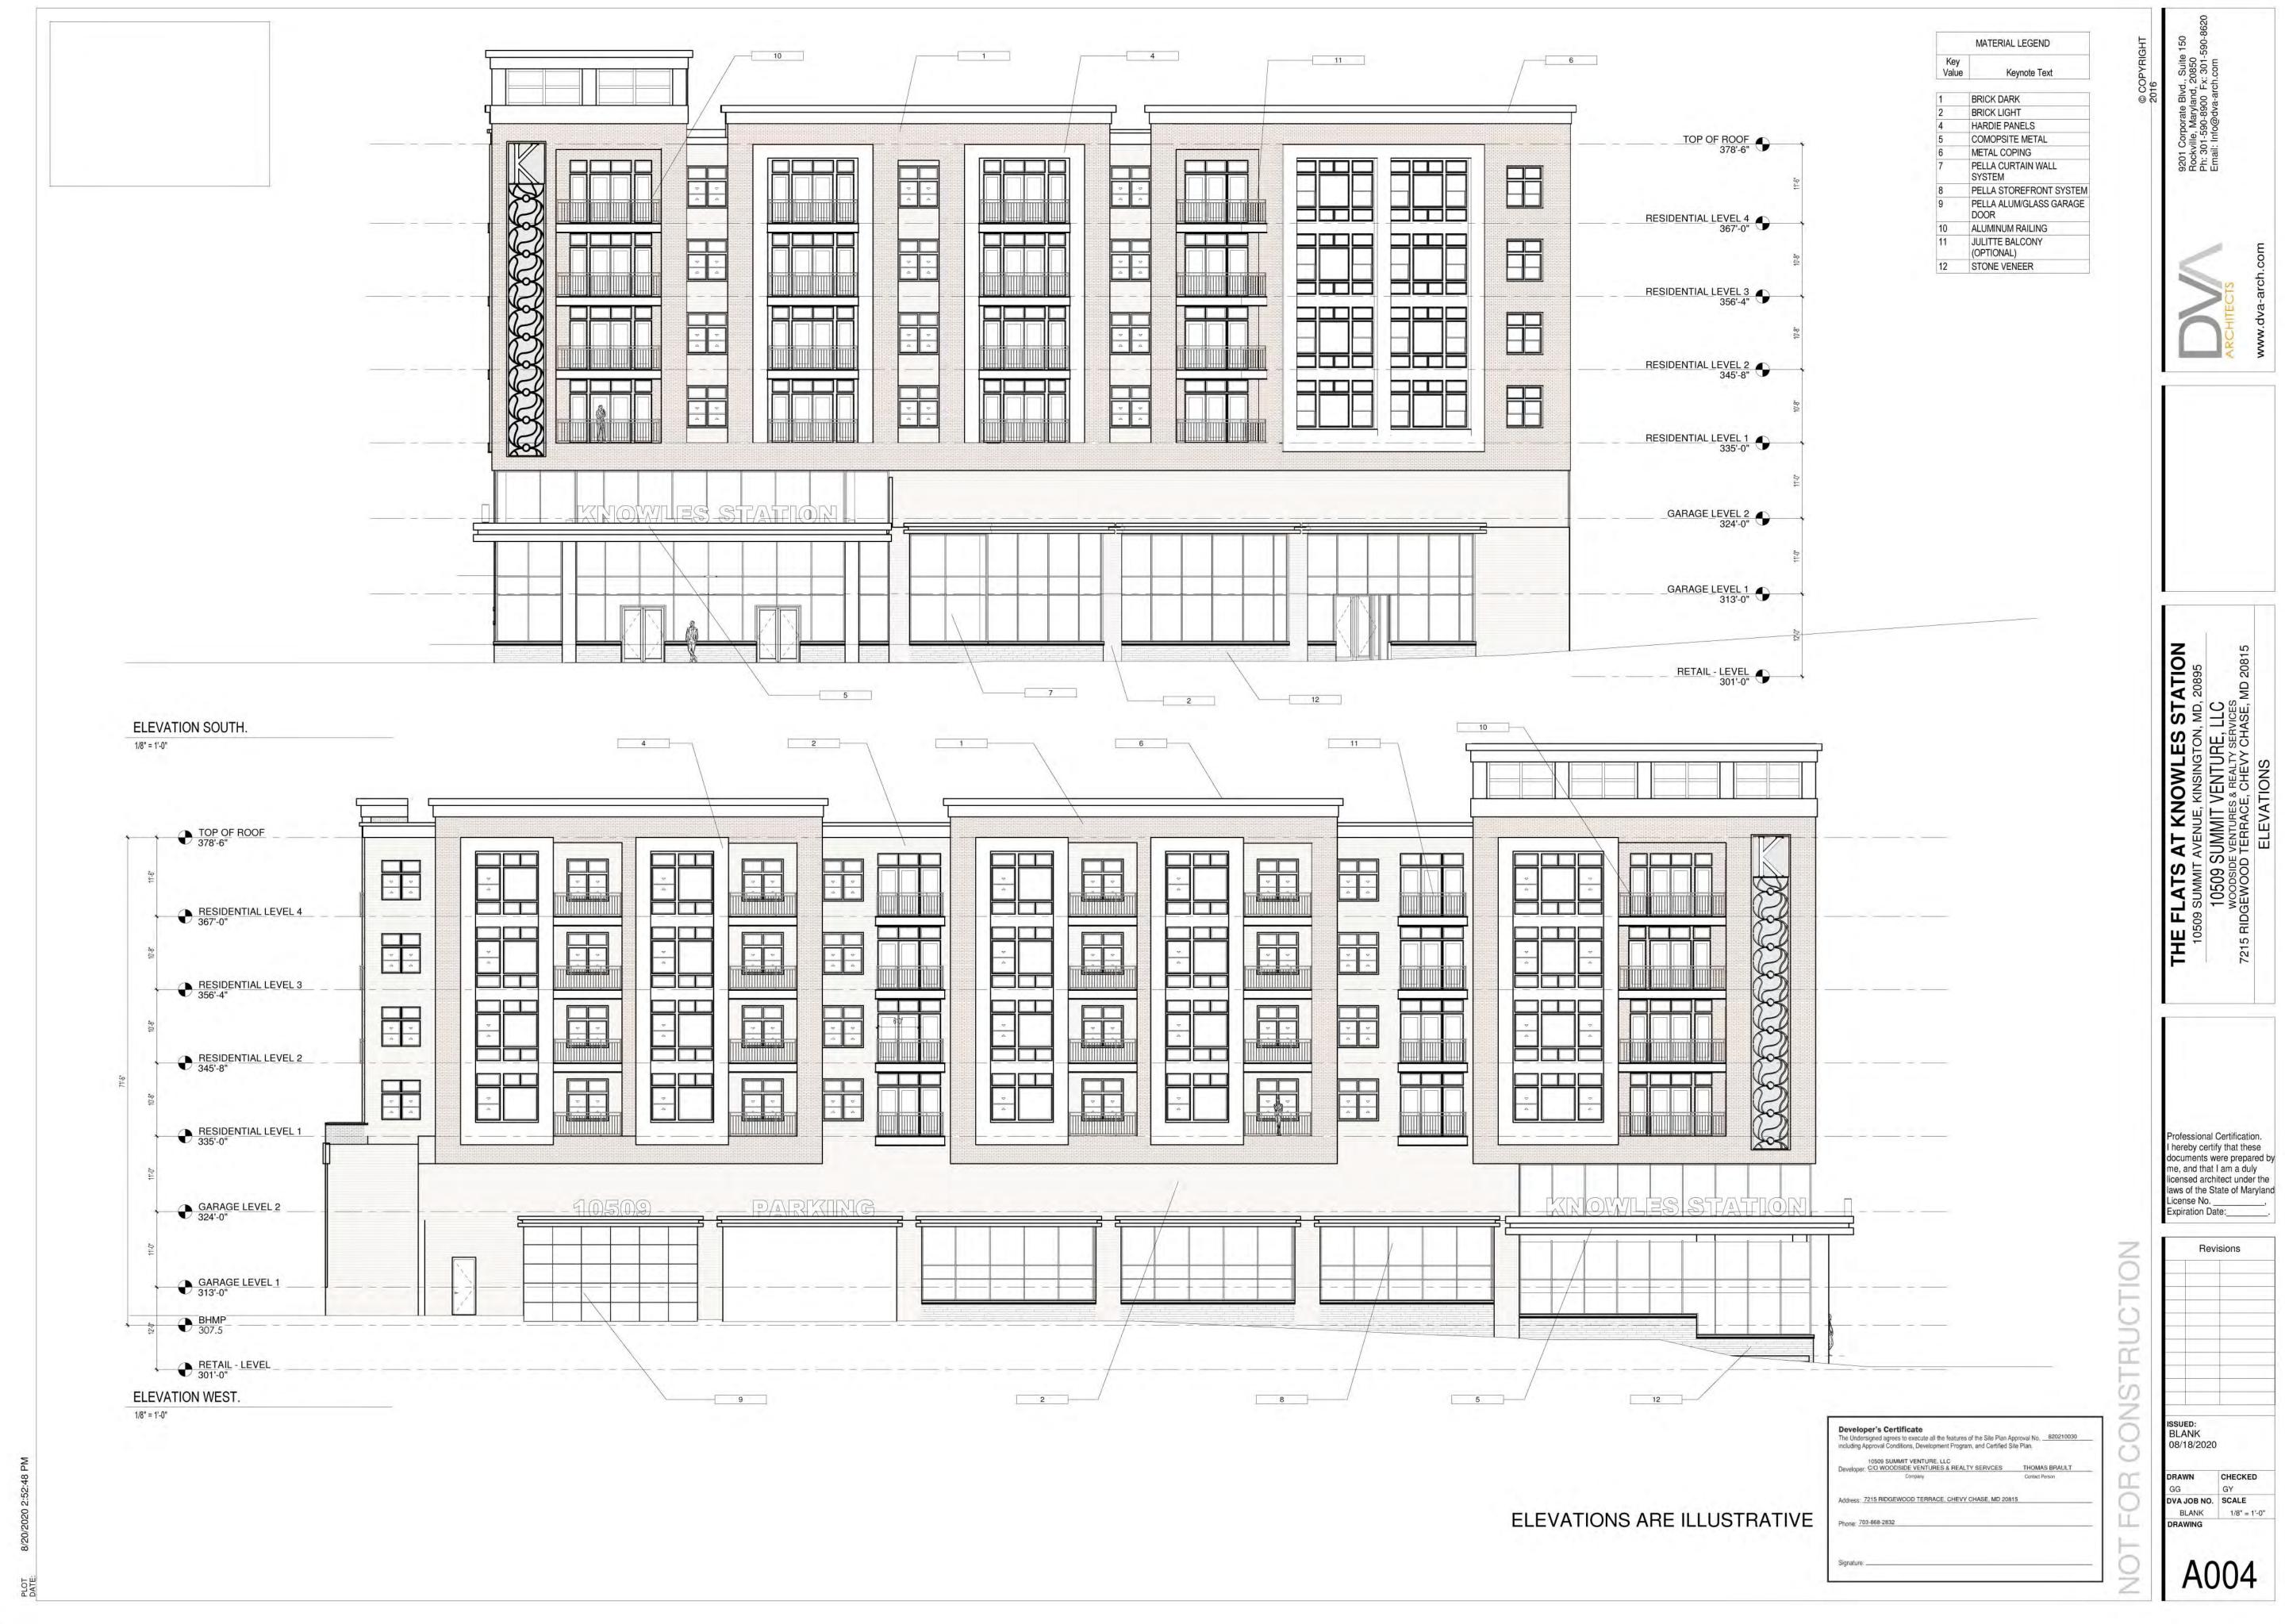






# The Residences at Knowles Station Site Plan

KENSINGTON, MARYLAND WOODSIDE VENTURES

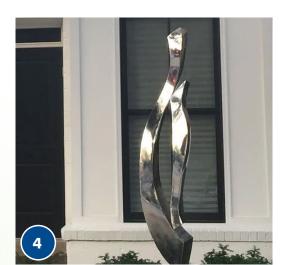








STORM WATER BOXES



SILVER LINDEN- Tilia tomentosa



PRINCETON SENTRY GINKGO -Ginkgo'Princeton Sentry'

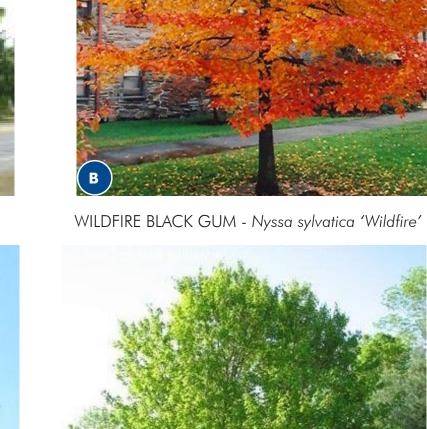



RED SUNSET RED MAPLE-Acer rubrum 'Franksred' RED SUNSET RED MAPLE



TONTO CRAPE MYRTLE -Lagerstromia indica x fauriei 'Tonto'



ARTIC FIRE RED TWIG DOGWOOD -Cornus stolonifera 'Farrow'





INKBERRY HOLLY llex glabra




SHENANDOAH SWITCH GRASS -Panicum virgatum 'Shenandoah'



OTTO LUYKEN LAUREL -Prunus laurocerasus 'Otto Luyken'



PENNSYLVANIA SEDGE -Carex pennsylvanica

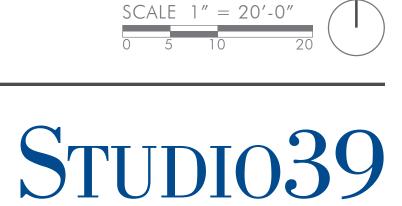

# THE FLATS AT KNOWLES STATION

### CLIENT

4000 KNOWLES VENTURE, LLC C/O WOODSIDE VENTURES & REALITY SERVICES BETHESDA, MD20815 CONTACT: THOMAS BRAULT TEL: (240) 670-3608

# ARCHITECT DVA ARCHITECTS


9201 CORPORATE BLVD, SUITE 150 ROCKVILLE, MD 20850 TEL: (301) 590-8900 CONTACT: GARY YUAN

CIVIL ENGINEER BOHLER ENGINEERING 16701 MELFORD BLVD, SUITE 310 BOWIE, MD 20715 TEL: (301) 809-4500 CONTACT: LAUREN WHITTEN

10509 SUMMIT AVENUE KENSINGTON, MARYLAND MONTGOMERY COUNTY

# SITE PLAN

AUGUST 18, 2020

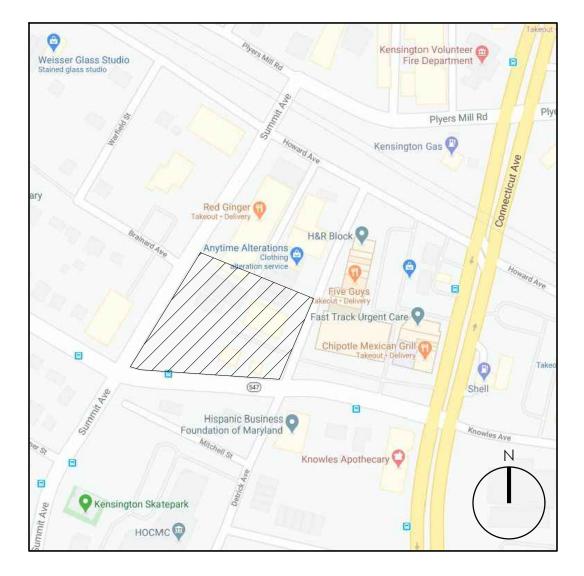

VICINITY MAP NOT TO SCALE

# LANDSCAPE ARCHITECT



LANDSCAPE ARCHITECTURE, P.C.

6416 GROVEDALE DRIVE, SUITE 100-A ALEXANDRIA, VIRGINIA 22310 TEL. (703) 719-6500 FAX (703) 719-6503 CONTACT: DAVID JUDD

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Sheet NumberSheet TitleL0.01GENERAL NOTESL1.00OVERALL PLANL1.01STREETSCAPE HARDSCAPE PLANL1.02COURTYARD & ROOF LEVEL HARDSCAPE PLAN	Sheet List Table						
L1.00OVERALL PLANL1.01STREETSCAPE HARDSCAPE PLAN	lumber Sł						
L1.01 STREETSCAPE HARDSCAPE PLAN	G	OTES					
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	ST	STREETSCAPE HARDSCAPE PLAN					
	C	COURTYARD & ROOF LEVEL HARDSCAPE PLAN					
L3.01 STREETSCAPE LANDSCAPE PLAN	ST	PE LANDSCAPE PLAN					
L3.10 PLANTING SCHEDULE	PL	SCHEDULE					
L3.11 PLANTING DETAILS	PL	DETAILS					
L4.01 PRODUCT INFORMATION	PF	NFORMATION					
L5.01 HARDSCAPE DETAILS	H	DETAILS					
L6.00 PHOTOMETRIC PLAN	PF	RIC PLAN					

## **REVISION INDEX**

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REVISION DATE REVISED ITEM DESCRIPTION

		LEGEND	
PROFESSIONAL TITLES			EXISTING INTERMEDIATE CONTOUR
ARCH ARCHITECT CIVIL CIVIL ENGINEER ENGR ENGINEER			EXISTING INDEX CONTOUR
GC GENERAL CONTRACTOR ID INTERIOR DESIGNER MEP MECHANICAL/ELECTRICAL/PLUMBING		9	PROPOSED INTERMEDIATE CONTOUR
LA LANDSCAPE ARCHITECT LC LANDSCAPE CONTRACTOR STR STRUCTURAL ENGINEER		10	PROPOSED INDEX CONTOUR
			EXISTING SPOT GRADE
		+ 00.00	PROPOSED SPOT GRADE
		ELEV.00.00	ELEVATION
STA STATION POINT STD STANDARD STL STEEL STM STORM DRAIN		STA 0+00.00 OFFSET 0'-0"	STATION POINT
SW SIDEWALK SWM STORM WATER MANAGEMENT			EASEMENT (PUE, PIE, ETC.)
T T&G TONGUE AND GROOVE TC TOP OF CURB, TOP OF COLUMN TD TRENCH DRAIN TEMP TEMPORARY			CENTER LINE
TS TOP OF STEP TW TOP OF WALL TXT TEXT		<u>e</u>	PROPERTY LINE
TYP TYPICAL U UNFIN UNFINISHED			RIGHT OF WAY
V VERT VERTICAL W W WEST			LOT LINE
WD WOOD WI WROUGHT IRON WLD WELDED WP WATER PROOFING			CENTER LINE OF SWALE
WR WATER RESISTANT WWM WELDED WIRE MESH WWR WELDED WIRE REINFORCEMENT		//	EXPANSION JOINT
Y YD YARD DRAIN			STEP
MATERIAL GRAPHICS			EXISTING LIGHT
	FABRIC SEPARATOR	÷¢-	PROPOSED POLE LIGHT
COMPACTED AGGREGATE SUB-BASE	STEEL / IRON	*	PROPOSED PEDESTRIAN LIGHT
			PROPOSED WALL LIGHT
SAND	ALUMINUM	$\oplus$	PROPOSED BOLLARD
MORTAR	BRASS / BRONZE / COPPER	$\oplus$	PROPOSED FOUNTAIN LIGHT
			PROPOSED FLOODLIGHT
MORTAR NEXT TO SAND SETTING BED	WOOD	$\nabla$	PROPOSED UPLIGHT
BRICK / PAVER	МИГСН	-	PROPOSED STEP LIGHT
		$\stackrel{\boxtimes}{\operatorname{SD}} \stackrel{\otimes}{\operatorname{SD}}$	SLAB DRAIN
DRAINAGE GRAVEL	PLASTIC	$\boxtimes \otimes$	SURFACE DRAIN / YARD DRAIN
SOIL / COMPACTED SOIL / UNDISTURBED SUBGRADE	ARCHITECTURAL PRECAST		TRENCH DRAIN
STRUCTURAL / PLANTING / LIGHTWEIGHT SOIL		# KEY	PLANT CALLOUT
EXPANSION JOINT W/ BACKER ROD	СМИ	DETAIL NAME	MATERIAL OR DETAIL CALLOUT
REBAR	RIGID INSULATION W/ OPEN JOINTS FOR DRAINAGE	# SHEET	ELEVATION CALLOUT
STONE	BRICK / CONCRETE PAVER	# SHEET	SECTION CALLOUT
ASPHALT CONCRETE W/ NEOPRENE TACK COAT	BRICK / CONCRETE PAVER HERRINGBONE		

### COMMON ABBREVIATIONS

A		AIR CONDITIONING AMERICAN ASSOCIATION OF STATE HWY & TRANSPORTATION. OFFICIALS ANCHOR BOLT ABRASIVE ABOVE		GFA GIP GL GP GVL
	AC ACD AD ADA ADEN ADD ADH ADJ ADJT A-E AFF AFG AGGR ALUM ANSI	ACRE ACCESS DOOR AREA DRAIN AMERICAN WITH DISABILITIES ACT ADDENDA, ADDENDUM ADDITIONAL ADHESIVE ADJACENT ADJUSTABLE ARCHITECT-ENGINEER ABOVE FINISH FLOOR ABOVE FINISH GRADE AGGREGATE ALUMINUM	I	HB HC HDPE HDWD HDWE HT HNDRL HORZ HP HS ID INSTL INV IP
	APPROX APT ASPH ASTM	APARTMENT ASPHALT	J L	JST JT LAM LB
В	AVE B&B BC BITUM BL BLDG BLK BLVD BM BMP	AVENUE BALL AND BURLAP BOTTOM OF CURB, BOTTOM OF COLUMN BEAM BITUMINOUS BASELINE BUILDING BLOCK BOULEVARD BENCHMARK BEST MANAGEMENT PRACTICES		LBR LH LOD LOS LOW LTP LP LS LT LTG LVL
	BOC BP BRK BRKT BRL BS BSMT BSMT BTWN BW BEV	BACK OF CURB BREAK POINT BRICK BRACKET BUILDING RESTRICTION LINE BOTTOM OF STEP BASEMENT BETWEEN BOTTOM OF WALL BEVEL	Μ	MAS MATL MAX MECH MED MET METB MFG MH MIN MISC
С	CB CC CEM CI CIP	CATCH BASIN CENTER TO CENTER CEMENT CAST IRON CAST IRON PIPE		MLDG MTG MULL MUTCD
	CIPC CJ CL CLO CLR CMU COL CONC	CAST-IN-PLACE CONCRETE CONTROL JOINT CENTER LINE CLOSET CLEAR CONCRETE MASONRY UNIT COLUMN CONCRETE	Ν	N N/A NIC NO NOM NTS
_	CONN CONST CONT COORD	CONNECTION CONSTRUCTION CONTINUOUS COORDINATE	0	OA OC OD OPNG OPT
D	DF DIA DIST DR DRN DWG DEMO DET DI DN DS DT DWL	DRINKING FOUNTAIN DIAMETER DIMENSION DISTANCE DRIVE DRAIN DRAWING DEMOLITION DETAIL DROP INLET DOWN DOWNSPOUT DRAIN TILE DOWEL	Ρ	ORIG PAR PERP PI PIE PKWY PL PLBG PLYWD PNL PNL PNT POB PR PRCST
E	E EA ELEC ELEC P ELEV ENCL ENTR EP EQ EQL SP	EAST EACH ELECTRICAL ELECTRICAL PANEL ELEVATION ENCLOSURE ENTRANCE EDGE OF PAVEMENT EQUAL EQUALLY SPACED		PRELIM PRKG PROP PSF PSI PT PTD PUE PVMT
	EQUIP ESMT ETD ETR ETRL ETRP EW EX EXP EXT	EQUIPMENT EASEMENT EXISTING TO BE DEMOLISHED EXISTING TO REMAIN EXISTING TO BE RELOCATED EXISTING TO BE REPLACED EACH WAY EXISTING EXPANSION EXTERIOR	R	R RC RDWY REC REF REQD RFD RH RIM RLG
F	FAR FBD FD FDN FFE FIN FIN FL FIN GR	FLOOR AREA RATIO FIBER BOARD FLOOR DRAIN FOUNDATION FINISHED FLOOR ELEVATION FINISH FINISH FLOOR FINISH GRADE	S	RM RND ROW RP RPA RTE S
	FN FOC FT FTG FUT FXTR	FENCE FRONT OF CURB FOOT/FEET FOOTING FUTURE FIXTURE		SD SECT SGL SJ SLP SM
G	GA GAB GALV GC GDR	GAUGE GRADED AGGREGATE BASE GALVANIZED GENERAL CONTRACTOR GUARD RAIL		SPEC SQ FT SQ IN SST ST

GFA GIP GL GP GVL	GROSS FLOOR AREA GALVANIZED IRON PIPE GLASS GUTTER PAN GRAVEL	S S S S S S S
HB HC HDPE HDWD HDWE HT HNDRL HORZ HP HS ID INSTL INV IP	HOSE BIBB HANDICAP PARKING SPACE HIGH DENSITY POLYETHYLENE PIPE HARDWOOD HARDWARE HEIGHT HANDRAIL HORIZONTAL HIGH POINT HARDSCAPE INSIDE DIAMETER INSTALLATION INVERT IRON PIPE	
JST JT	JOIST JOINT	
LAM LB LH LOD LOS LOW LTP LP LS LT LTG LVL	LAMINATED POUND LUMBER LEFT HAND LIMITS OF DISTURBANCE LINE OF SIGHT LIMITS OF WORK LIGHT POLE LOW POINT LANDSCAPE LIGHT LIGHTING LEVEL	V V V V V V V V V V V V V V V V V V V
MAS MATL MAX MECH MED MET MFG MH MIN MISC MLDG MTG MULL MUTCD	MASONRY MATERIAL MAXIMUM MECHANICAL MEDIUM METAL METAL BASE MANUFACTURING MANHOLE MINIMUM MISCELLANEOUS MOLDING MOUNTING MULLION MANUAL OF UNIFORM TRAFFIC CONTROL DEVICES	
N N/A NIC NO NOM NTS	NORTH NOT APPLICABLE NOT IN CONTRACT NUMBER NOMINAL NOT TO SCALE	
OA OC OD OPNG OPT ORIG	OVERALL ON CENTER OUTSIDE DIAMETER OPENING OPTIONAL ORIGINAL	
Par Perp Pi Pie Pkwy Pl Plbg Plywd	PARALLEL PERPENDICULAR POINT OF INTERSECTION PUBLIC IMPROVEMENT EASEMENT PARKWAY PROPERTY LINE PLUMBING PLYWOOD	
PNL PNT POB PR	PANEL PAINT POINT OF BEGINNING PAIR PRECAST	
PSF PSI PT PTD PUE PVMT	POUNDS PER SQUARE FOOT POUNDS PER SQUARE INCH PRESSURE TREATED PAINTED PUBLIC UTILITY EASEMENT PAVEMENT	
R RC RDWY REC REF REQD RFD RH RIM RLG RM RND ROW RP RPA RTE	RISER, RADIUS REINFORCED CONCRETE ROAD ROADWAY RECESSED REFERENCE REQUIRED ROOF DRAIN RIGHT HAND DRAIN INLET RIM ELEVATION RAILING ROOM ROUND RIGHT OF WAY RADIUS POINT RESOURCE PROTECTION AREA ROUTE	
S SD SECT SGL SJ SLP SM	SOUTH SURFACE DRAIN SECTION SINGLE SCORED JOINT SLOPE SMOOTH	
SPEC SQ FT		

SQUARE INCH

STREET

STAINLESS STEEL

## GENERAL NOTES

GENERAL LAYOUT NOTES:

- 1. BASE TOPOGRAPHICAL AND EXISTING CONDITIONS TAKEN FROM DRAWING FURNISHED BY XXXXXXX.
- 2. DRAWINGS PREPARED FROM CIVIL AND ARCHITECTURAL DRAWINGS, NOT AS-BUILT DATA PREPARED BY <u>xxxxxxx</u>, DATED <u>xxxxxxx</u>, AND PREPARED BY <u>xxxxxxx</u>, DATED <u>xxxxxxx</u>.
- 3. UTILITY WORK IS NOT INDICATED ON THIS DRAWING. REFER TO CIVIL DRAWINGS FOR WORK RELATED TO UTILITIES.
- 4. DO NOT SCALE THESE DRAWINGS.
- 5. DIMENSIONS ARE FROM BACK OF CURB, TO FACE OF WALL, TO OUTSIDE EDGE OF PAVEMENTS; FROM COLUMN CENTERLINES TO HARDSCAPE CENTERLINES, TO CENTERLINE OF PAVEMENTS, TO OUTSIDE EDGE OF PAVEMENTS, TO CENTERLINES OF STAIRS; FROM EDGE OF PAVEMENT TO FACE OF WALL UNLESS OTHERWISE SPECIFIED.
- 6. ALL CURVES TO BE TRUE RADII WITHOUT STRAIGHT SEGMENTS.
- 7. ALL ANGLES ARE 90° UNLESS OTHERWISE NOTED.
- 8. CHANGES IN LAYOUT MAY BE MADE AT THIS TIME TO ACCOMMODATE DESIGN INTENT OR FIELD CONDITIONS. NO ADDITIONAL PAYMENT WILL BE MADE TO THE CONTRACTOR FOR THIS WORK.
- 9. CONTRACTOR TO NOTIFY LANDSCAPE ARCHITECT IMMEDIATELY OF ANY DISCREPANCIES FOUND IN PLANS AND ANY CONFLICTS ENCOUNTERED IN FIELD.
- 10. QUANTITIES REFERENCED IN PLANS ARE SHOWN AS A COURTESY ONLY. CONTRACTOR IS RESPONSIBLE FOR VERIFYING ALL QUANTITIES.
- 11. CONTRACTOR SHALL VERIFY ALL DIMENSIONS PRIOR TO CONSTRUCTION.
- 12. ALL WALLS, SIDEWALKS, PATHWAYS, FENCES, AND STAIRWAYS SHALL BE COMPLETELY LAID OUT AND STAKED WITH VISIBLE MARKERS. THE STAKES SHALL BE APPROVED IN THE FIELD BY LANDSCAPE ARCHITECT PRIOR TO CONSTRUCTION. THE CONTRACTOR SHALL NOTIFY LANDSCAPE ARCHITECT 48 HOURS PRIOR TO SITE VISIT.
- 13. CONTRACTOR IS RESPONSIBLE FOR ALL WIRING, CONDUIT, FOOTINGS, PERMITS, ETC. NECESSARY TO COMPLETE SITE LIGHTING INSTALLATION. CONTRACTOR TO COORDINATE POWER CONNECTIONS WITH ELECTRICAL ENGINEER AND OWNER.
- 14. BENCH AND LITTER RECEPTACLE LAYOUT SHOWN IS APPROXIMATE. LAYOUT TO BE APPROVED IN THE FIELD BY LANDSCAPE ARCHITECT.

THE FLATS AT KNOWLES STATION

10509 SUMMIT AVENUE KENSINGTON, MARYLAND MONTGOMERY COUNTY

CLIENT 4000 KNOWLES VENTURE, LLC C/O WOODSIDE VENTURES & REALITY

SERVICES



5416 GROVEDALE DR., SUITE 100-A
ALEXANDRIA, VIRGINIA 22310
703.719.6500   STUDIO39.COM

seal/signature

ISSUE DATE

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© STUDIO39 LANDSCAPE ARCHITECTURE, P.C.

20005

Y.J

DJ

DAVID JUDD

1"=0'-0"

PROJECT NUMBER:

APPROVED/CHECKED:

ORIENTATION AND SCALE


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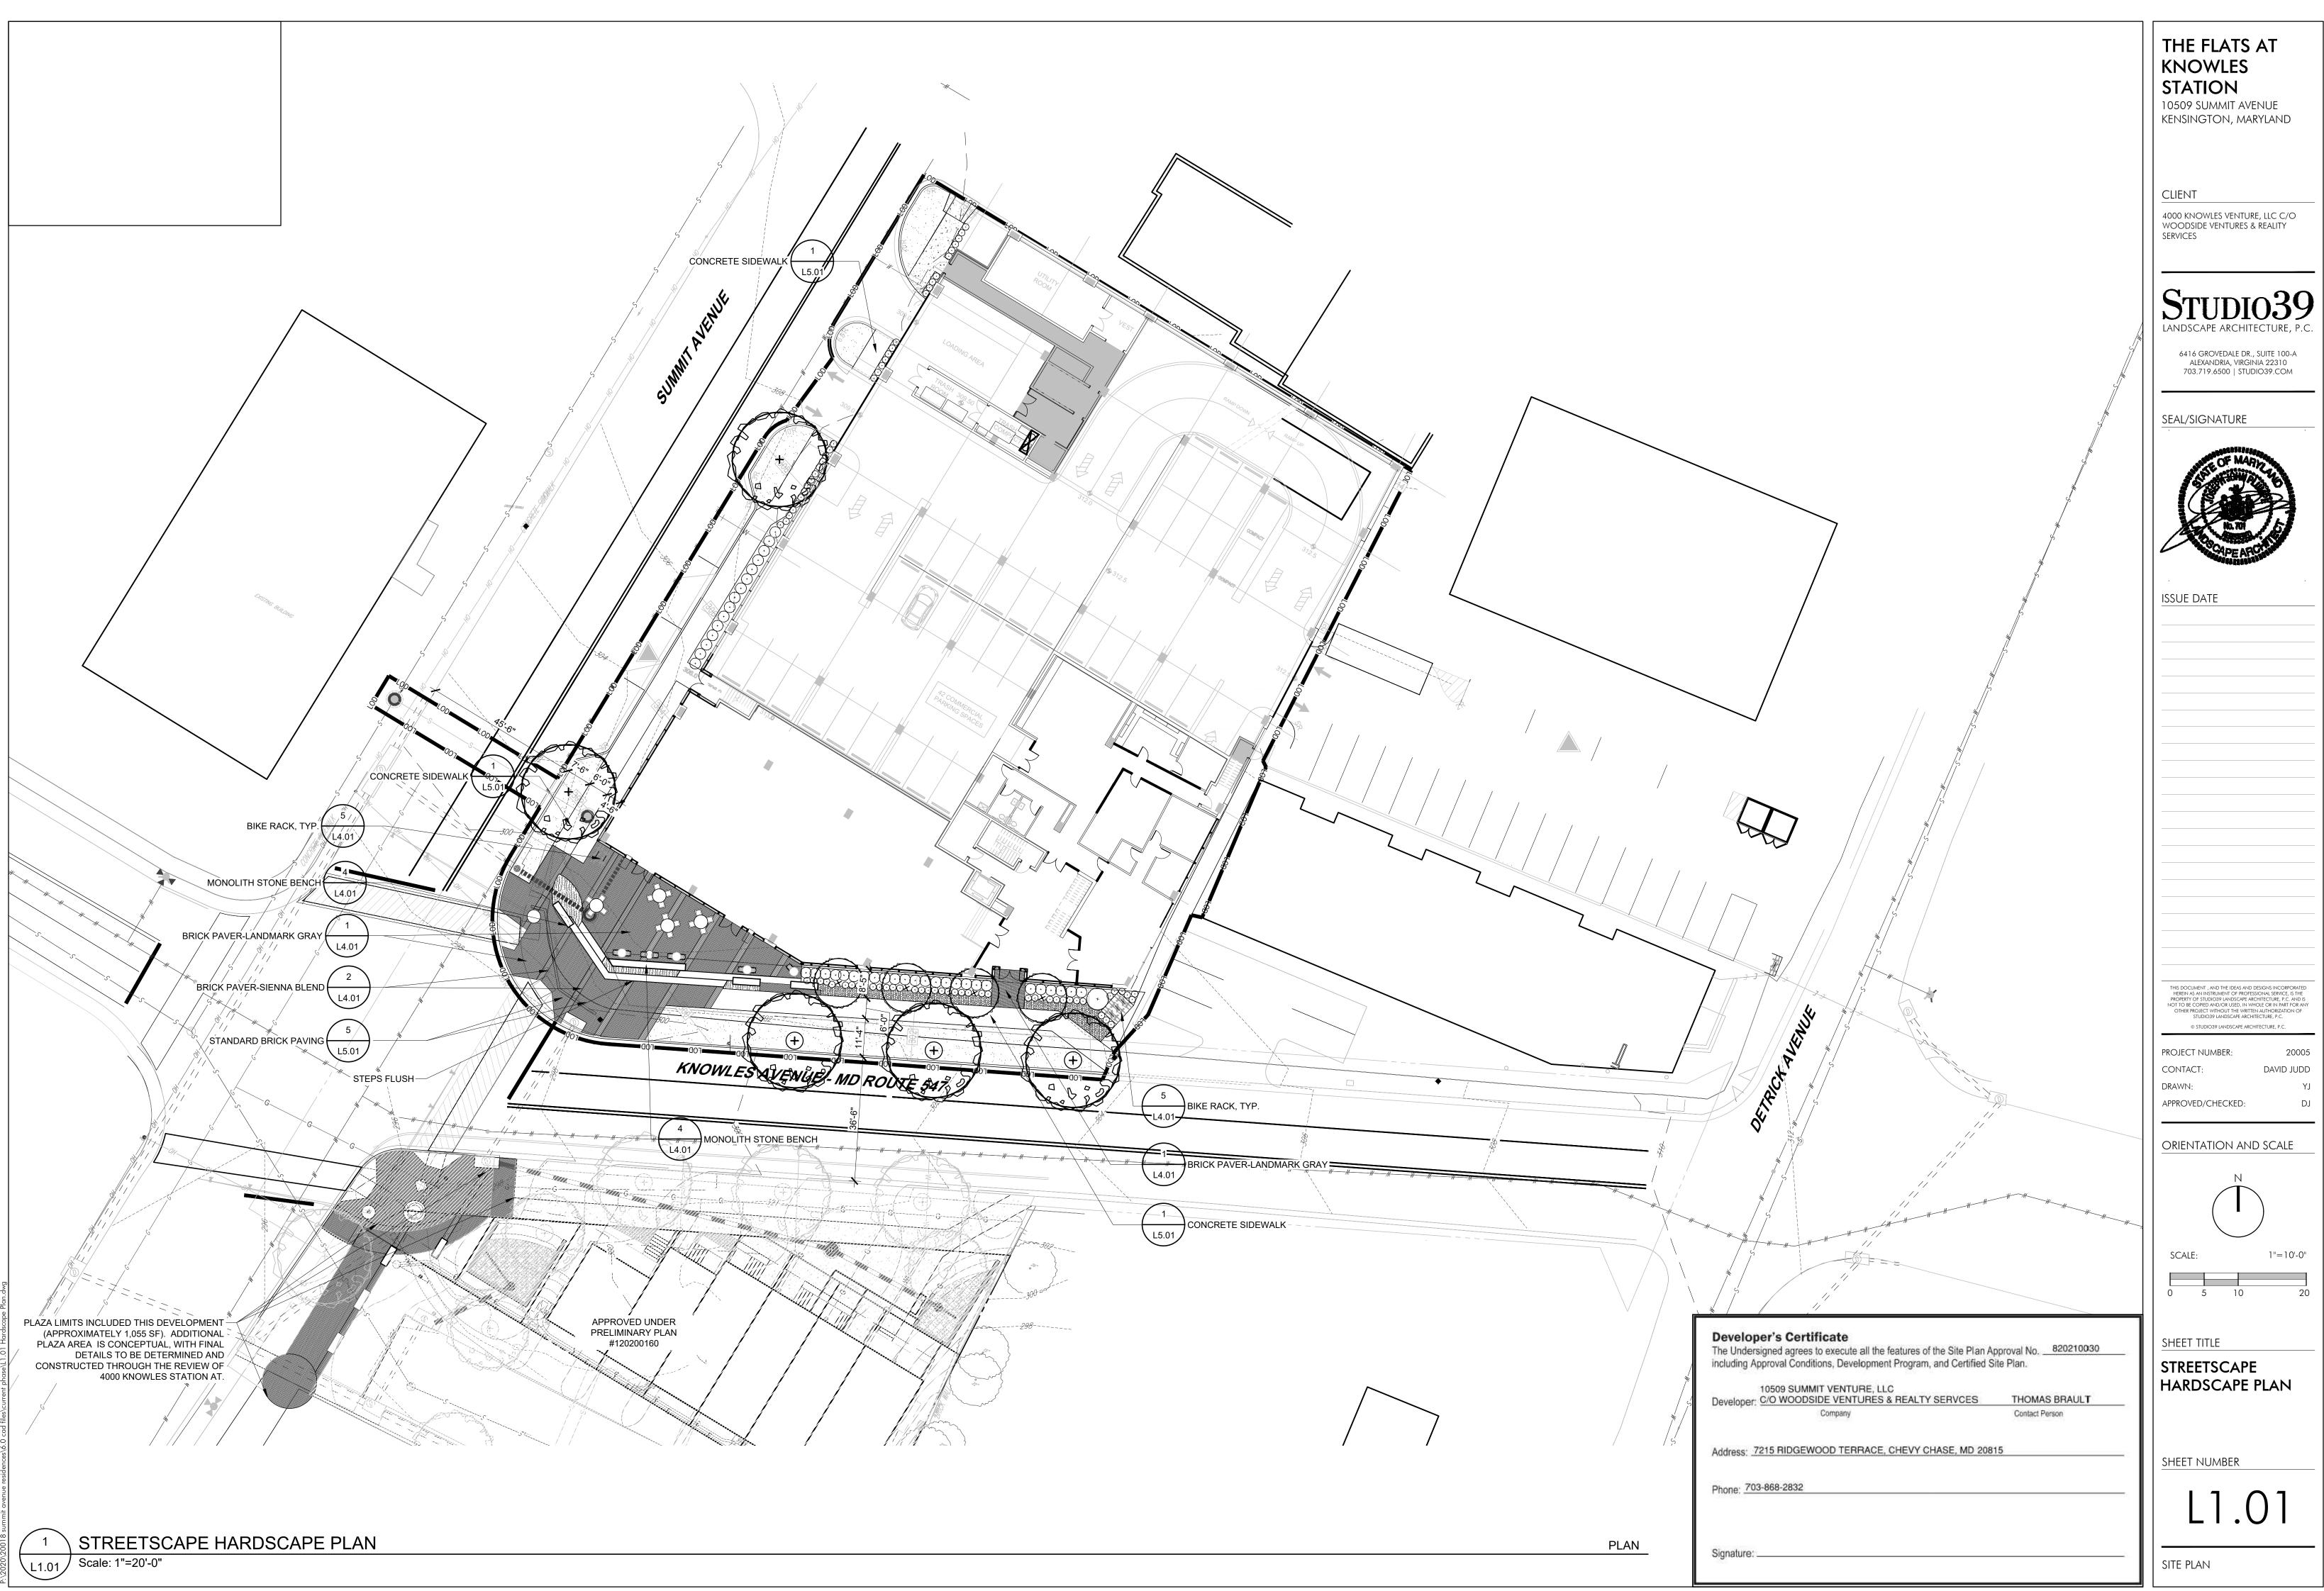
CONTACT:


SCALE:

DRAWN:

Developer's Certificate The Undersigned agrees to execute all the features of the Site Plan Approval Conditions, Development Program, and Certified S	GENERAL NOTES	
10509 SUMMIT VENTURE, LLC Developer: C/O WOODSIDE VENTURES & REALTY SERVCES Company	THOMAS BRAULT	<i>6</i>
Address: 7215 RIDGEWOOD TERRACE, CHEVY CHASE, MD 208	15	SHEET NUMBER
Phone: 703-868-2832		L0.01
Signature:		SITE PLAN




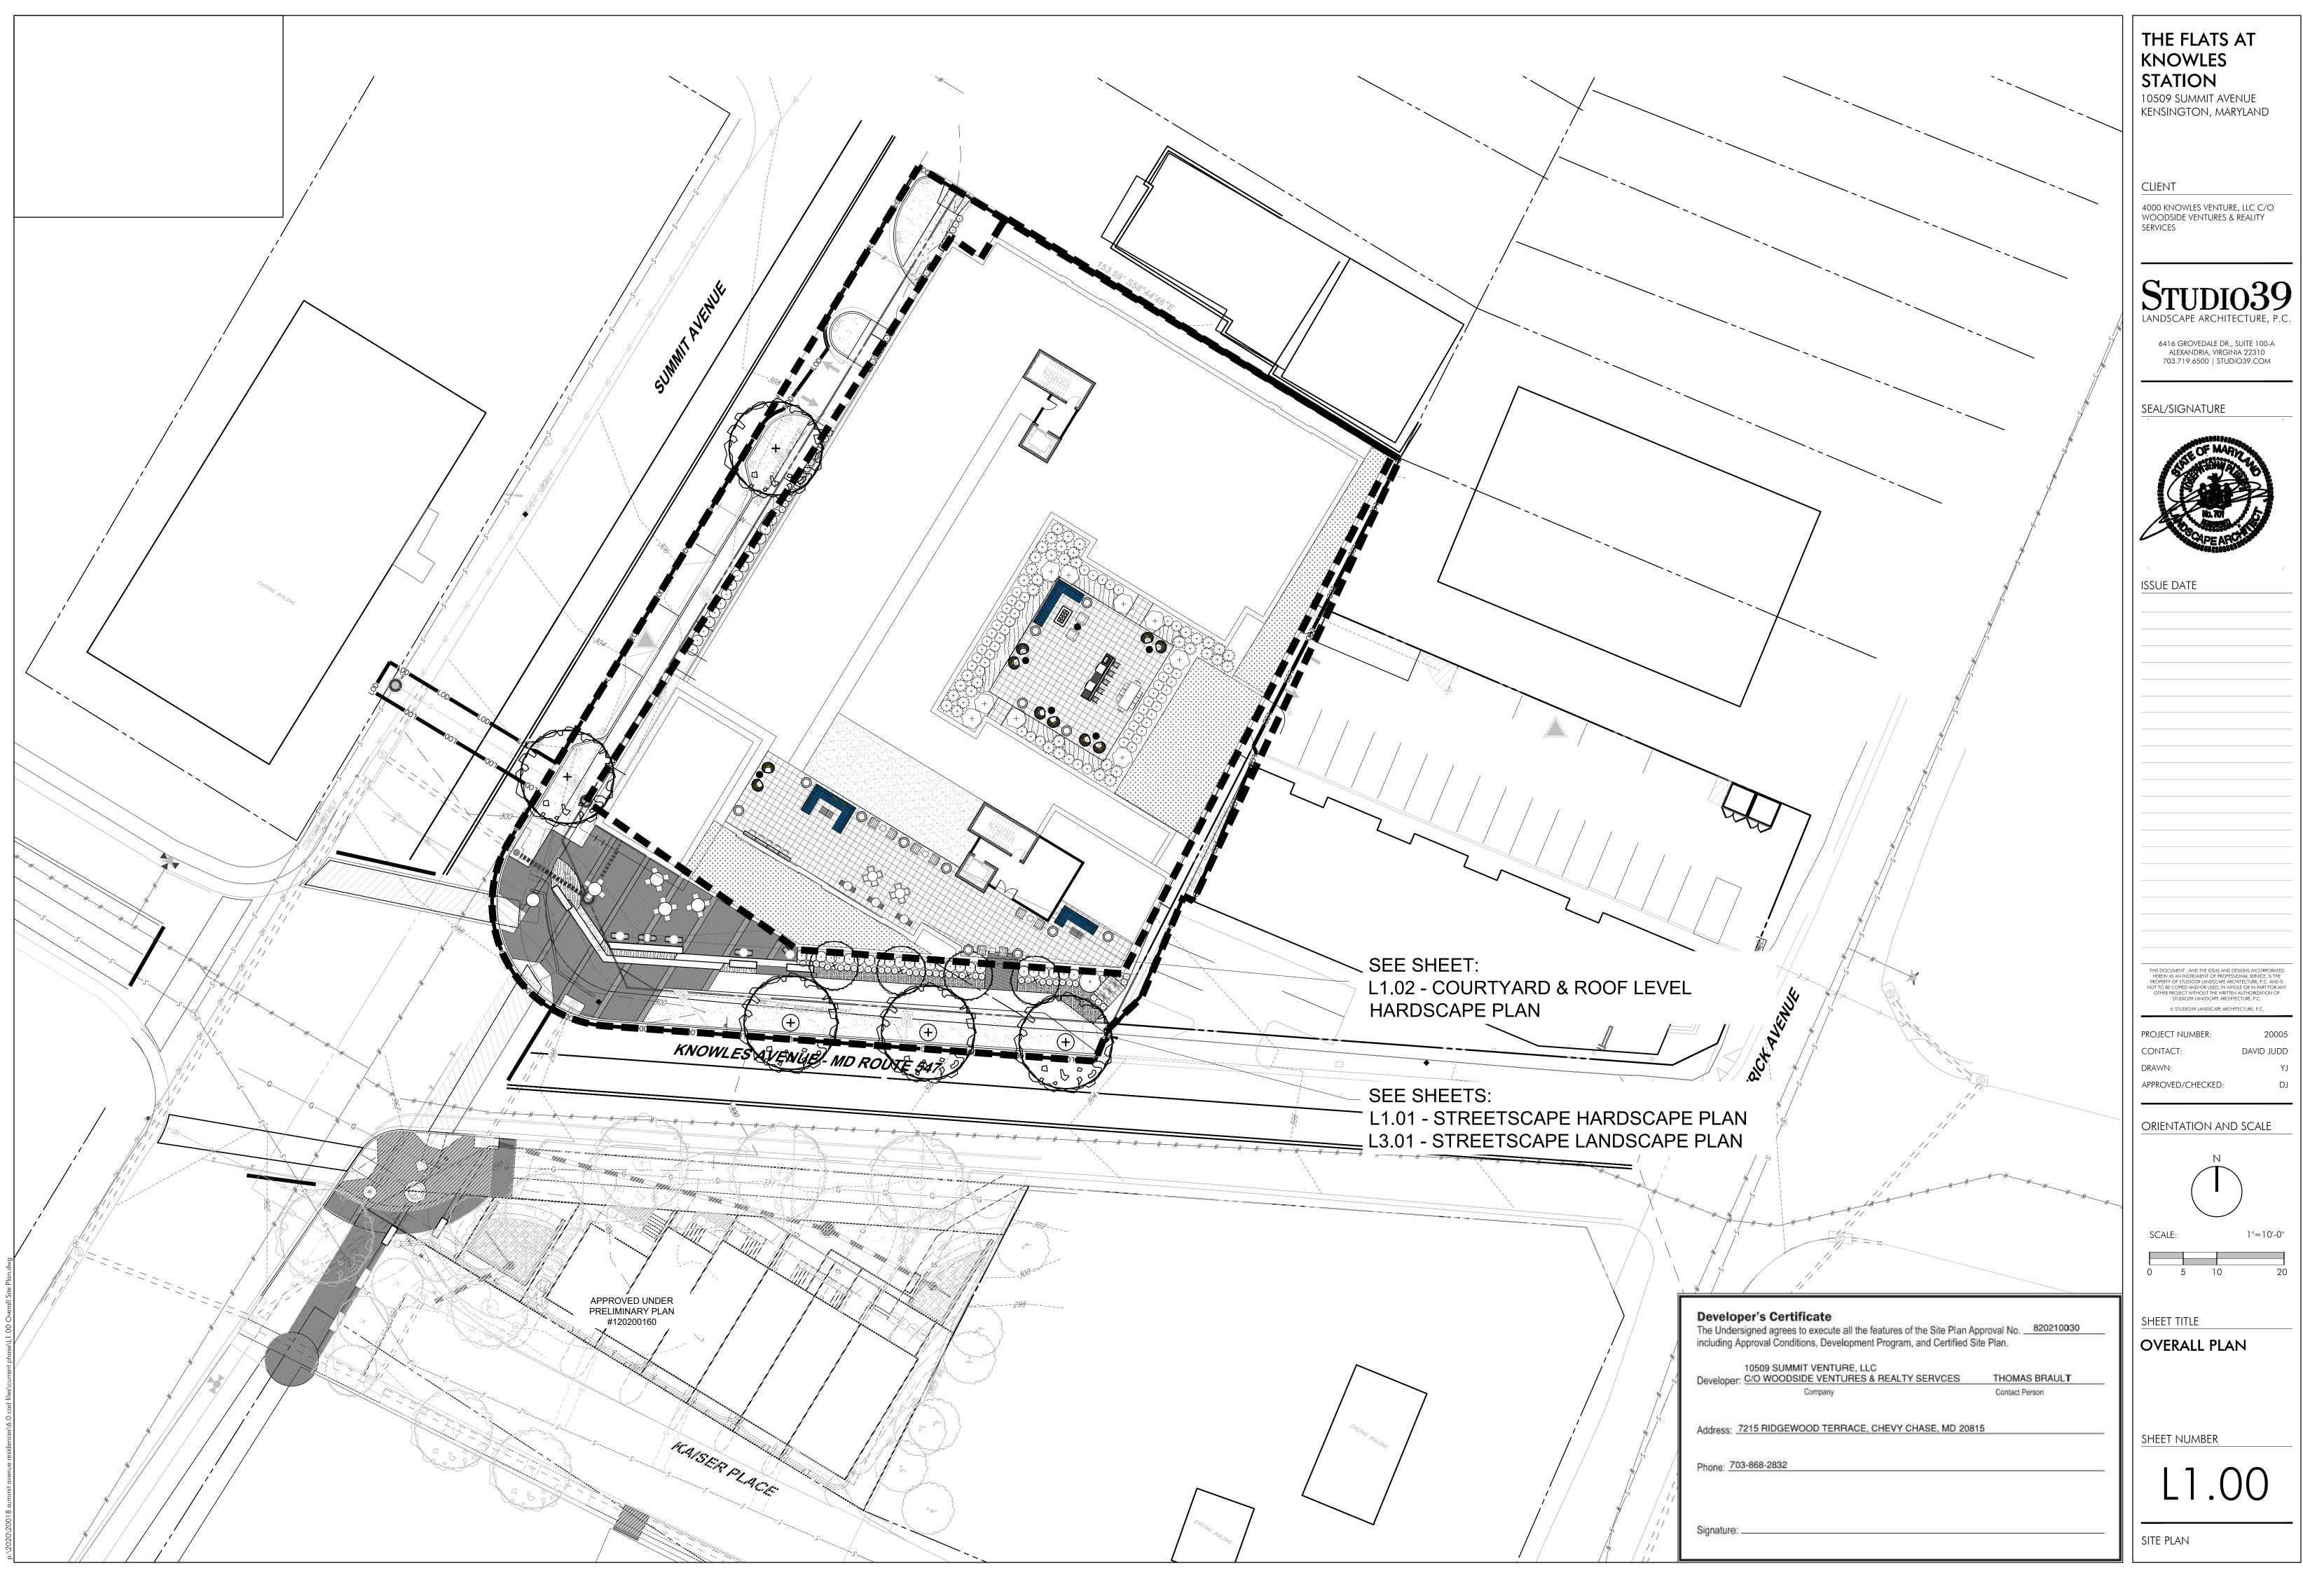

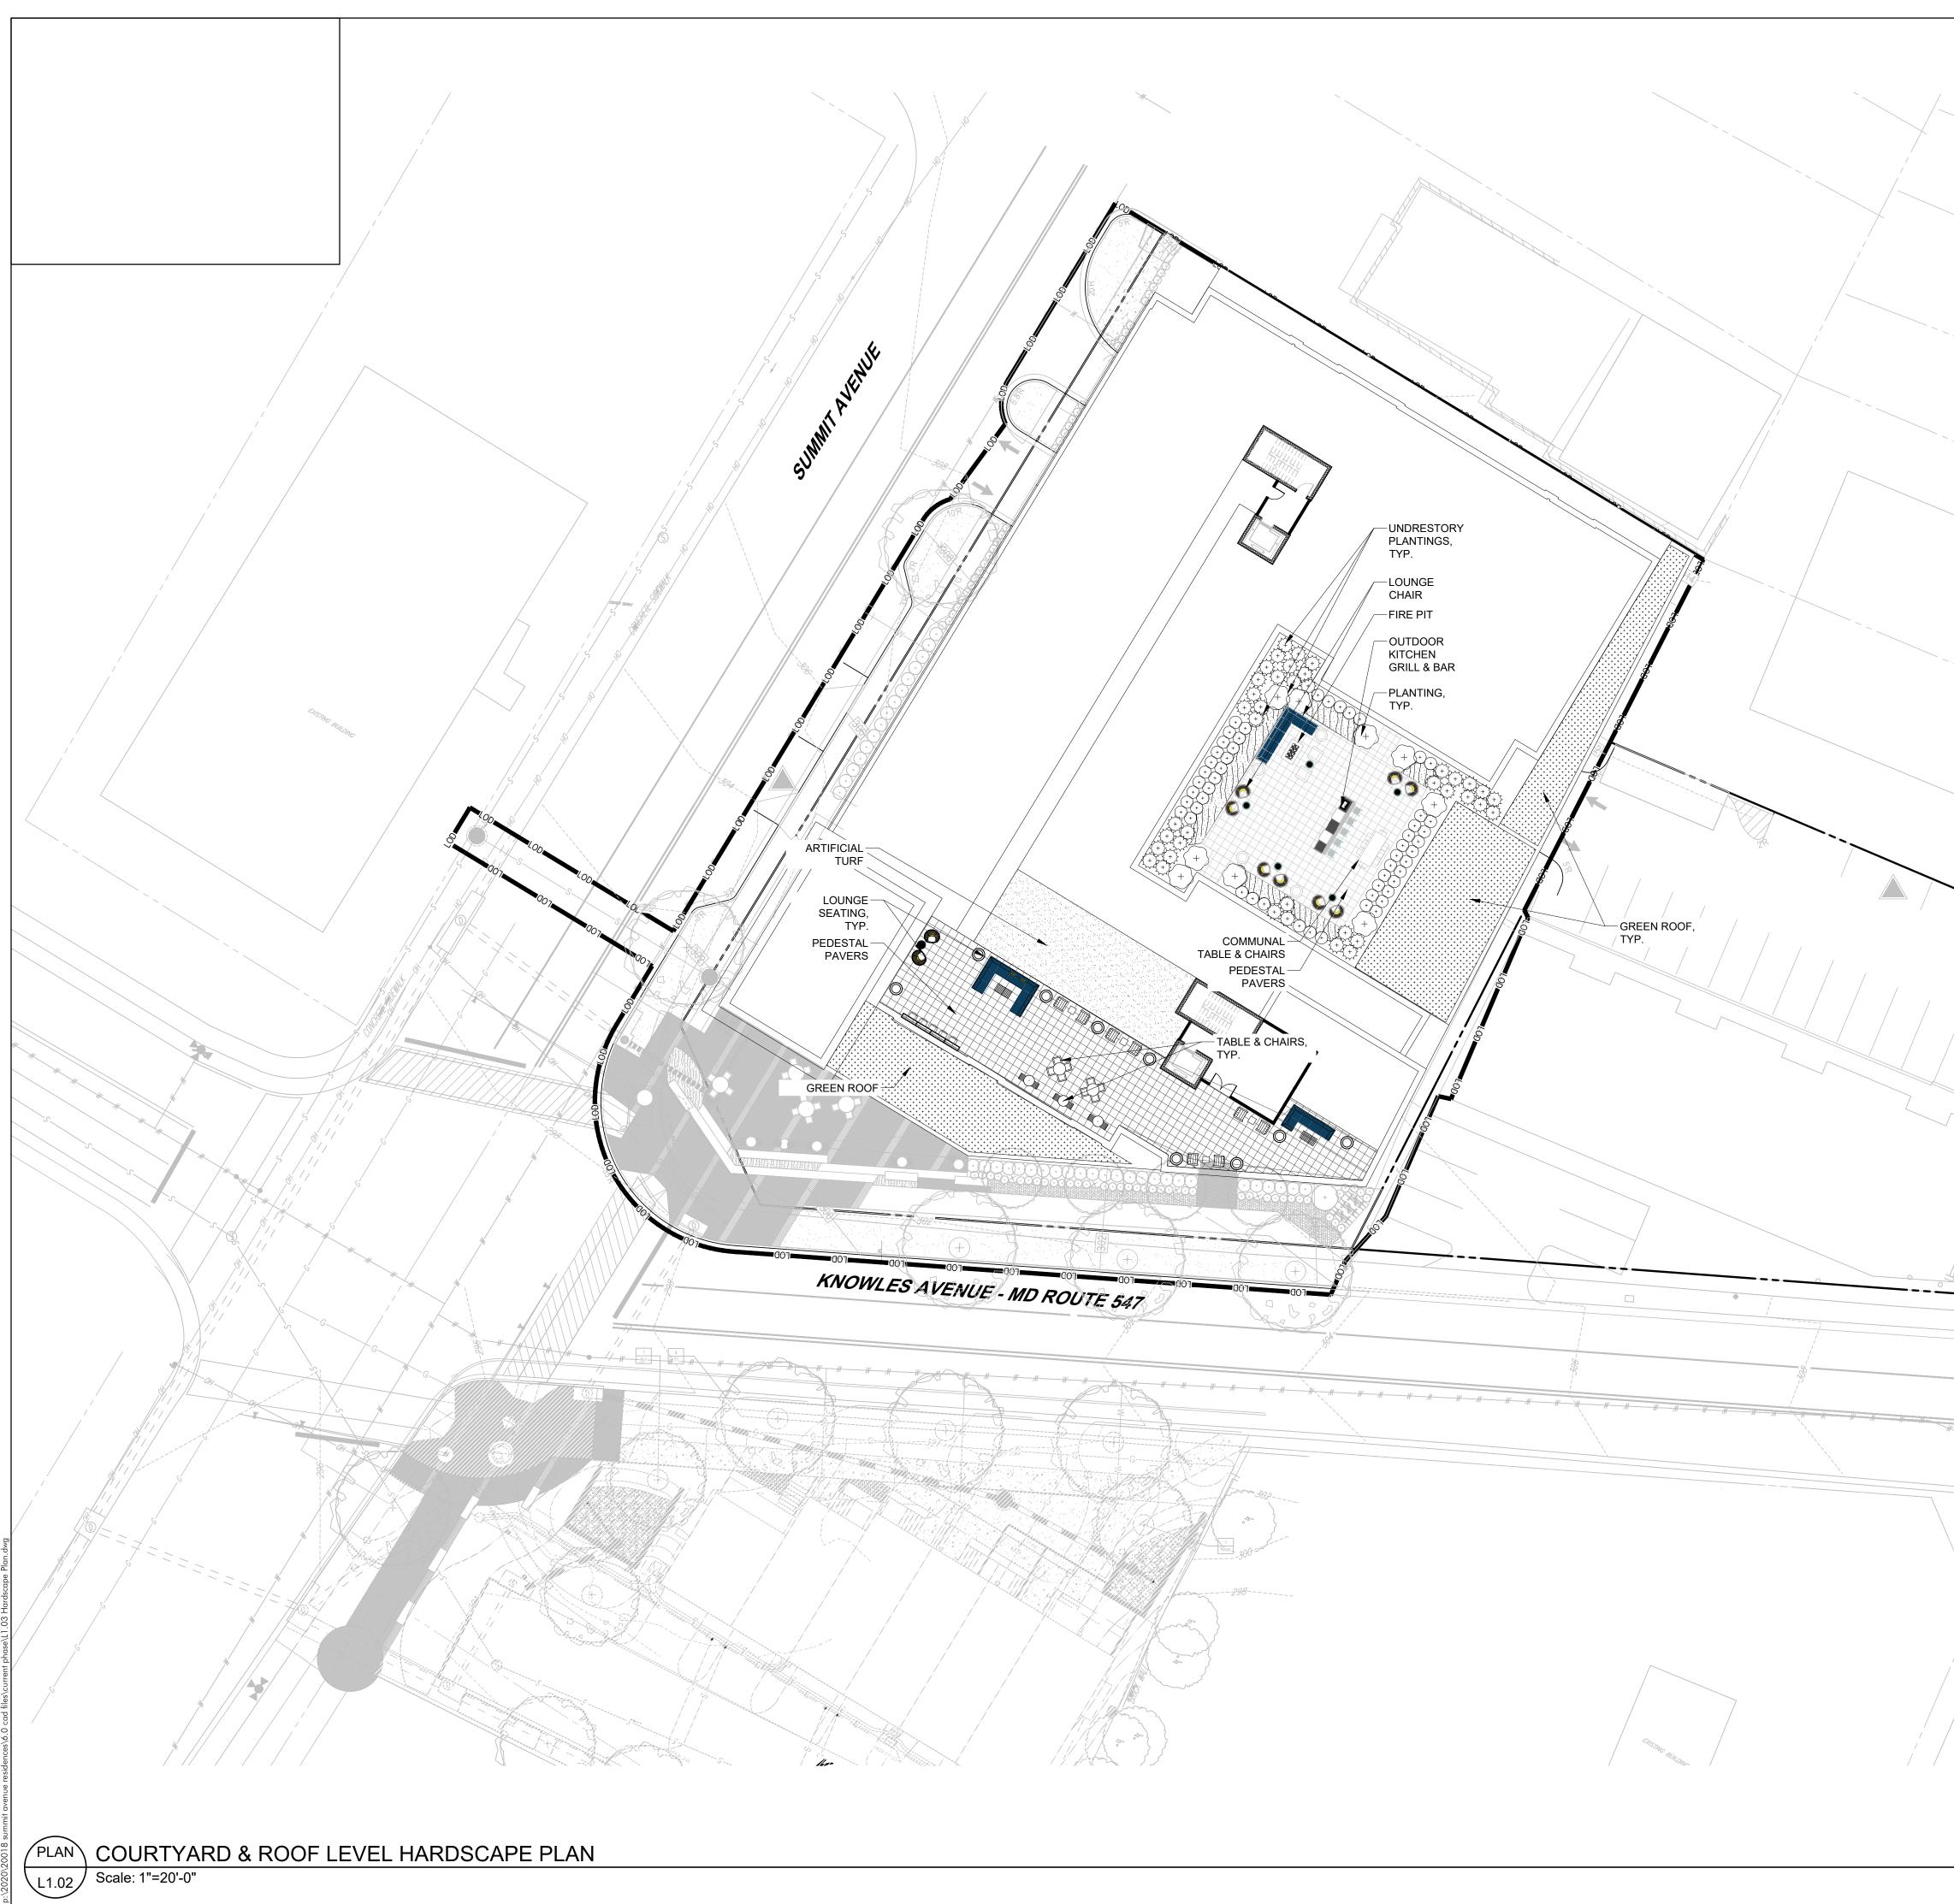

		THE FLATS AT KNOWLES STATION
		10509 SUMMIT AVENUE KENSINGTON, MARYLAND
		CLIENT
		4000 KNOWLES VENTURE, LLC C/O WOODSIDE VENTURES & REALITY
		SERVICES
		STUDIO39
		LANDSCAPE ARCHITECTURE, P.C.
		6416 GROVEDALE DR., SUITE 100-A
		ALEXANDRIA, VIRGINIA 22310 703.719.6500   STUDIO39.COM
		SEAL/SIGNATURE
		AND
		STER STORY PLANE
		No. THE AS
		CAPE ARCHINE
		ISSUE DATE
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	The the the terms of term	THIS DOCUMENT, AND THE IDEAS AND DESIGNS INCORPORATED
		HEREIN AS AN INSTRUMENT OF PROFESSIONAL SERVICE, IS THE PROPERTY OF STUDIO39 (ANDSCAPE ARCHITECTURE, P.C. AND IS NOT TO BE COPIED AND/OR USED, IN WHOLE OR IN PART FOR ANY OTHER PROJECT WITHOUT THE WRITTEN AUTHORIZATION OF
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		PROJECT NUMBER: 20005
0		CONTACT: DAVID JUDD DRAWN: YJ
	A A A A A A A A A A A A A A A A A A A	APPROVED/CHECKED: DJ
0.		ORIENTATION AND SCALE
~~~~~~~~~~~~~~~~~~~~~~~~~~~~~~~~~~~~~~		
**	the state of the s	
		SCALE: 1"=10'-0"
		0 5 10 20
	Developer's Certificate	
	The Undersigned agrees to execute all the features of the Site Plan Approval No. 820210030 including Approval Conditions, Development Program, and Certified Site Plan.	SHEET TITLE
	10509 SUMMIT VENTURE, LLC	COURTYARD & ROOF LEVEL
	Developer: C/O WOODSIDE VENTURES & REALTY SERVCES THOMAS BRAULT Company Contact Person	HARDSCAPE PLAN
- M	Address: 7215 RIDGEWOOD TERRACE, CHEVY CHASE, MD 20815	SHEET NUMBER
	Phone: 703-868-2832	
		L1.02
PLAN	Signature:	
	- Synatoro.	SITE PLAN

**OT RELEASED FOR CONSTRU** 

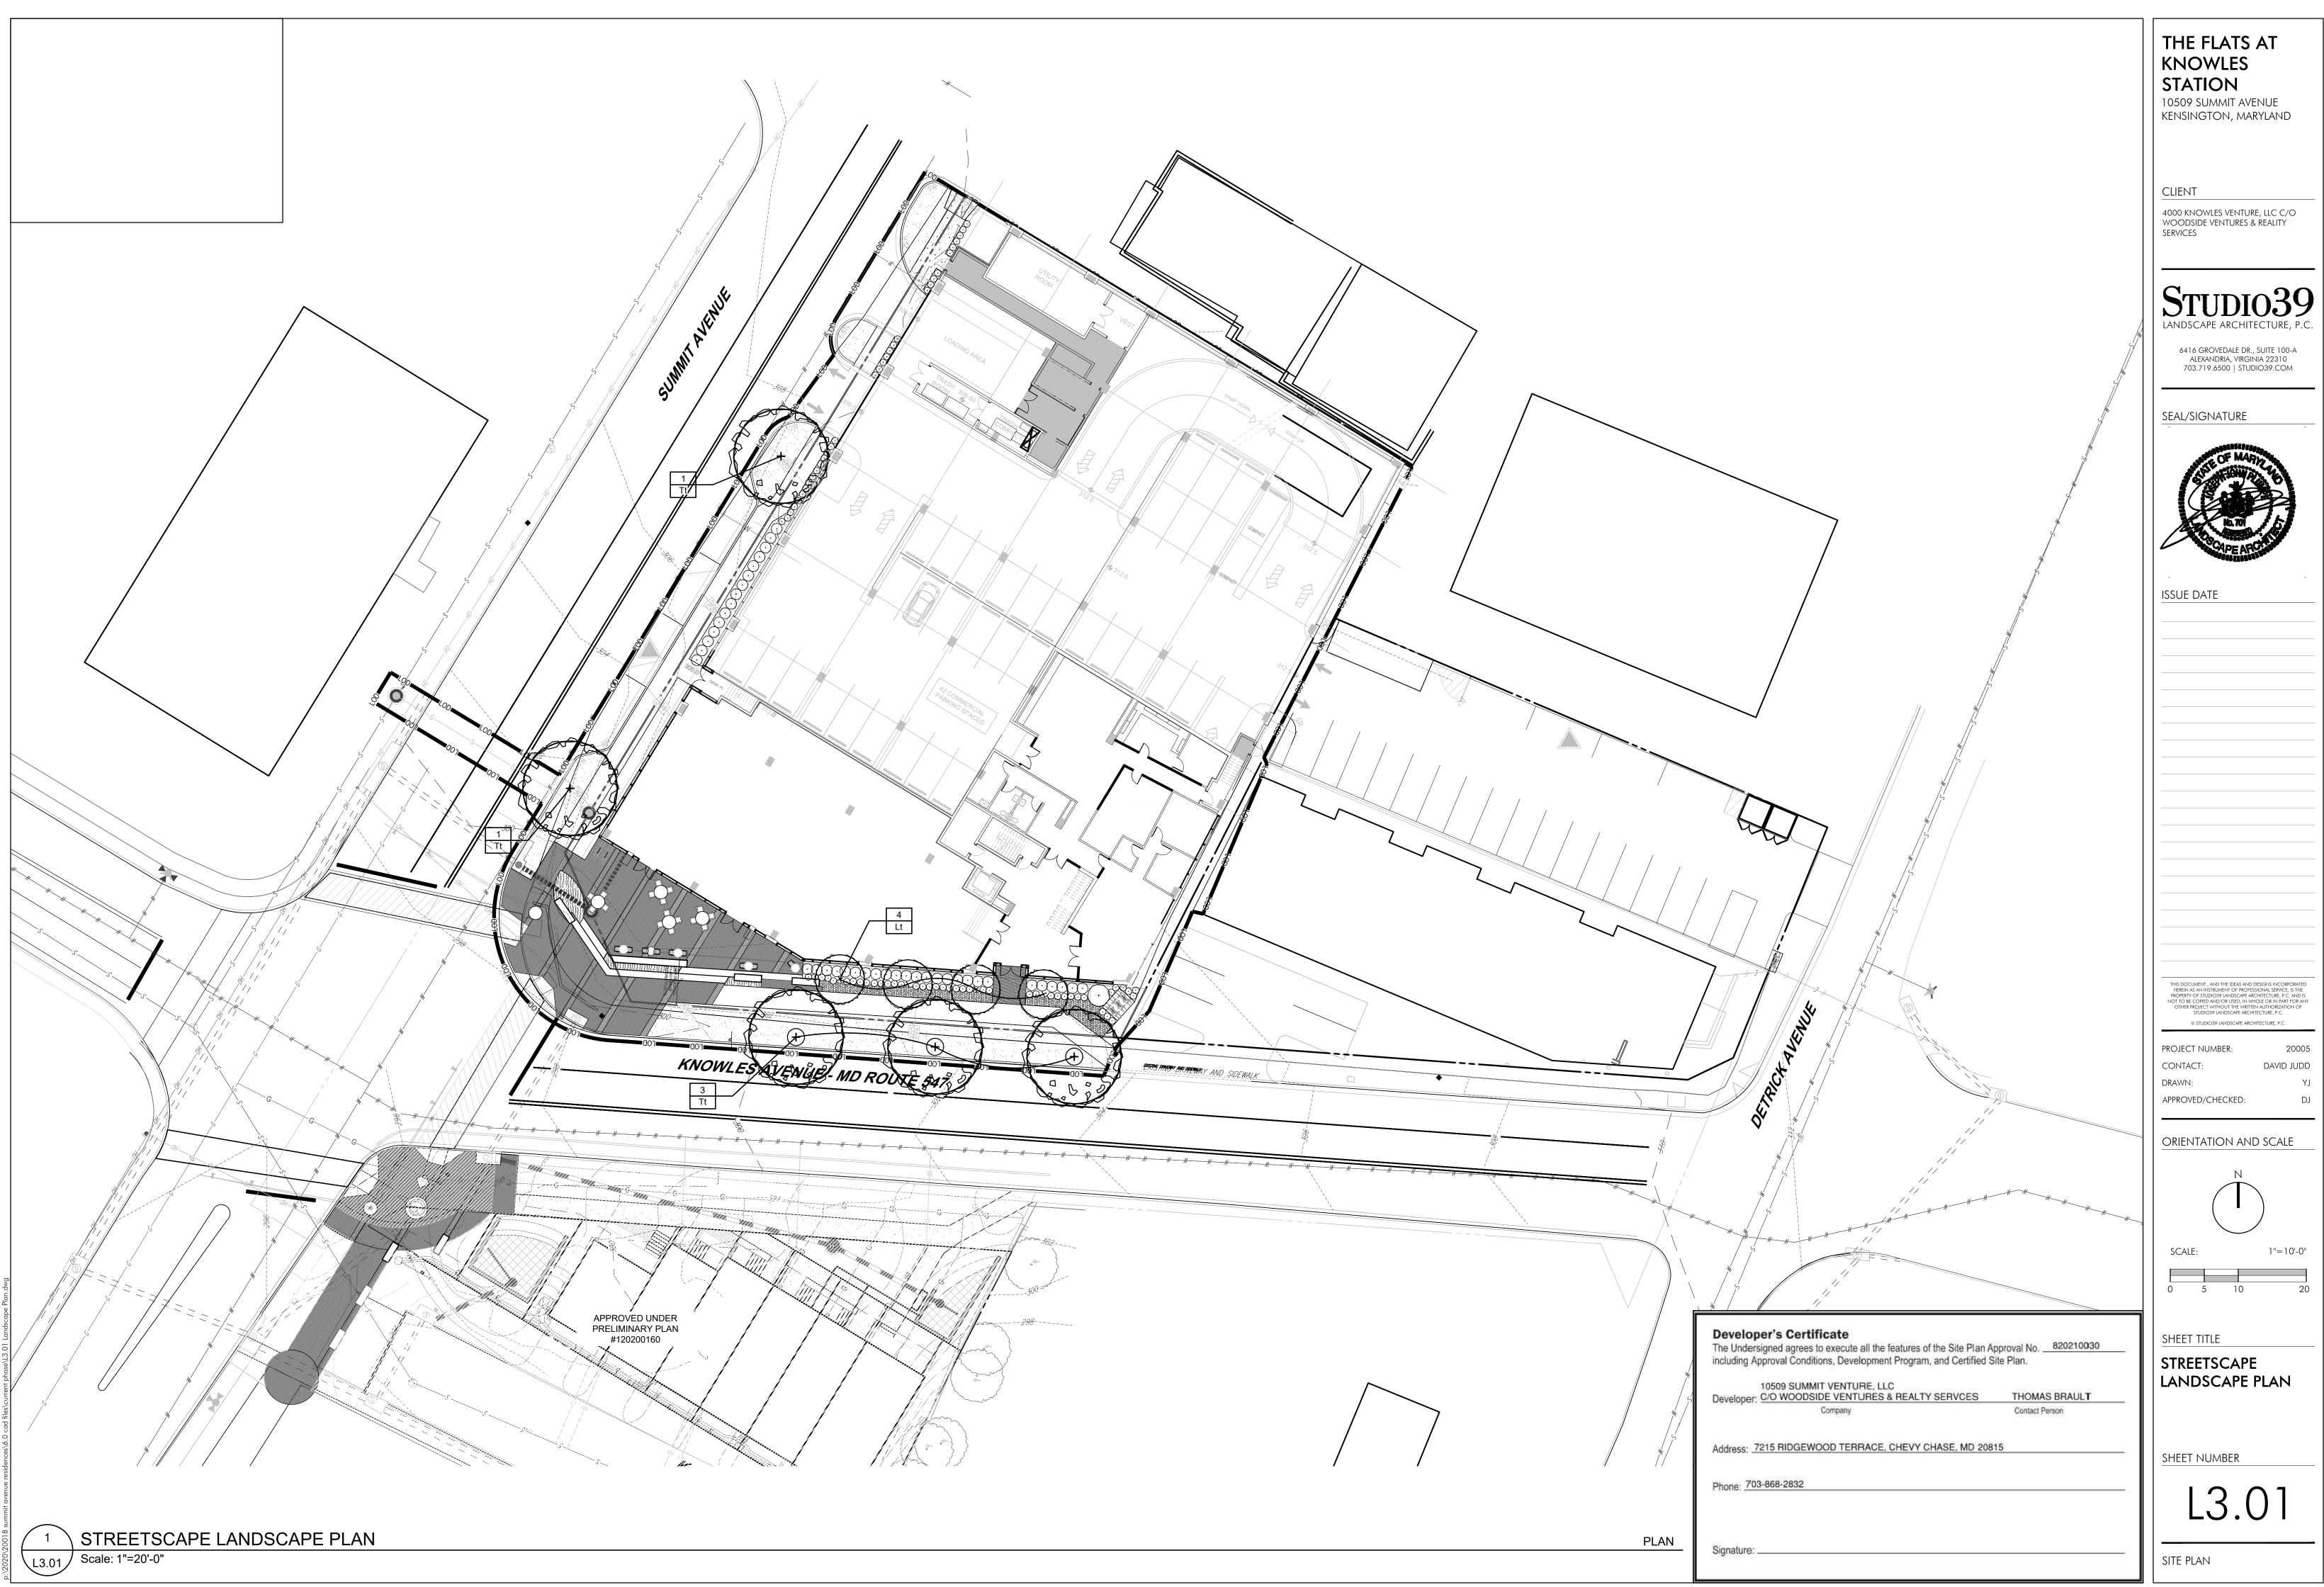

# **RECOMMENDED TREES**

PLANT SCHEDULE SUMMIT FIRST FLOOR								
SHADE TREES QTY		BOTANICAL NAME	COMMON NAME HEIGHT		CALIPER	REMARKS		
Tt 5 Tilia tomentosa		Tilia tomentosa	Silver Linden	14`-16`	3" - 3 1/2"	B&B, full uniform crown, symmetrical branching, full specimen		
ORNAMENTAL TREES	QTY	BOTANICAL NAME	COMMON NAME	HEIGHT	CALIPER	REMARKS		
Lt	4	Lagerstroemia indica x fauriei `Tonto`	Tonto Crapemyrtle	8`-10`	1 1/2" min.	B & B, multi-trunk, 3 trunk minimum, full symmetrical branching		

# **RECOMMENDED PLANT POOL**

SHRUBS

QTY	KEY GENUS	SPECIES	VARIETY	COMMON NAME	HEIGHT	SPREAD	REMARKS
-	COS Cornus	COS Cornus serícea		Red Twig Dogwood 24 - 36		24 - 36"	<b>#</b> 5 cont., healthy, ∨igorous, well-rooted <b>\$</b> established
-	FGM Fothergilla	gardenii	'Mt. Airy'	Mt. Airy Fothergilla	18 - 24"	18 - 24"	#3 cont., healthy, vigorous, well-rooted ∉ established in container
-	IGS liex	glabra	'Shamrock'	Shamrock Inkberry	24 - 30"	18 - 24"	#3 cont., healthy, vigorous, well-rooted ∉ established in container
-	PJM Pieris	japonica	'Mountain Fire'	Japanese Pieris	24 - 30"	18 - 24"	#3 cont., healthy vigorous, well-rooted & established in container
-	PLO Prunus	laurocerasus	'Otto Luykens'	Otto Luykens Cherry Laurel	18 - 24"	18 - 24"	#3 cont., healthy vigorous, well-rooted & established in container
-	RGC Rhododendron		'Girard's Crimson'	Girard's Crimson Azalea	15 - 18"	15 - 18"	#3 cont., healthy, vigorous, well-rooted ≰ established in container

### PERENNIAI S/ORNAMENTAL GRASSES

				-			-
QTY	KEY	GENUS	SPECIES	VARIETY	COMMON NAME	SIZE	COLOR
-	DEC	Deschampsia	cespitosa		Tufted Hair Grass	#1 cont.	
-	LAH	Lavandula	angustifolia	'Hidcote'	Hidcote Lavender	#1 cont.	Purple
-	MUH	Muhlenbergia	capillaris		Pink Muhly Grass		
-	PVH	Panicum	virgatum	'Hea∨y Metai'	Heavy Metal Switch Grass	#3 cont.	
-	GP	Gaultheria	procumbens		Creeping Wintergreen	#1 cont.	
ROUND	COVE	RS					
QTY	KEY	GENUS	SPECIES	VARIETY	COMMON NAME	SIZE	COLOR
	LMB	Liriope	muscari	'Big Blue'	Big Blue Liriope	1 qt.	
-						· · ·	

\*PLANT MATERIAL SPECIES MAY BE CHANGED DUE TO AVAILABILITY AT TIME OF CONSTRUCTION.

### STORM WATER PLANT POOL

SHRUBS

				r	r		
QTY	KEY	GENUS	SPECIES	VARIETY	COMMON NAME	HEIGHT	CALIPER
-	CsK	Cornus	serícea	'Kelsyi'	Redtwig Dogwood	24 - 30"	18 - 24"
-	lgD	llex	glabra	'Densa'	Shamrock Inkberry	24 - 30"	18 - 24"
-	IvL	ltea	virginica	'Little Henry'	Little Henry Sweetspire	18 - 24"	18 - 24"
-	PoC	Physocarpus	opulifolius	'Coppertina'	Coppertina Ninebark	24 - 30"	24 - 30"

### PERENNIALS/ORNAMENTAL GRASSES/FERNS

_		IALS/							
	QTY	KEY	GENUS	SPECIES	VARIETY	COMMON NAME	HEIGHT	CALIPER	Ш
	-	AnP	Aster	novae-angliae	'Purple Dome'	Purple Dome Aster	#1 cont.	Purple	18
	-	Εp	Echinacea	purpurea		Purple Coneflower	#1 cont.	Pink	18
	-	١٧	Irís	versicolor		Blue Flag Iris	#1 cont.	Violet-blue	2
	-	MdR	Monarda	didyma	'Raspberry Wine'	Bee Balm	#1 cont.		2
	-	Mc	Muhlenbergia	capillaris		White Muhly Grass	#3 cont.		2
	-	PVD	Panicum	virgatum	'Dallas Blues'	Dallas Blues Switch Grass	#3 cont.		2
Γ	-	Pv9	Panicum	virgatum	'Shenandoah'	Shenandoah Switch Grass	#3 cont.		2
Γ	-	PmF	Phlox	macaulata	'Flower Power'	Summer Phlox	#1 cont.		2
Γ	-	Rhi	Rudbeckía	hirta	'Indian Summer'	Black-eyed Susan	#1 cont.	Yellow	18
	-	SsP	Schizachyrium	scoparium	'Prarie Blues'	Little Bluestem	#3 cont.	Yellow	18

\*PLANT MATERIAL SPECIES MAY BE CHANGED DUE TO AVAILABILITY AT TIME OF CONSTRUCTION.

REMARKS
18" o.c., full specimen, healthy, vigorous, well-rooted and established
18" o.c., full specimen, healthy, vigorous, well-rooted and established
24" o.c., full specimen, healthy, vigorous, well-rooted and established
24" o.c., full specimen, healthy, vigorous, well-rooted and established
24" o.c., full specimen, healthy, vigorous, well-rooted and established
24" o.c., full specimen, healthy, vigorous, well-rooted and established
24" o.c., full specimen, healthy, vigorous, well-rooted and established
24" o.c., full specimen, healthy, vigorous, well-rooted and established
18" o.c., full specimen, healthy, vigorous, well-rooted and established
18" o.c., full specimen, healthy, vigorous, well-rooted and established


REMARKS
#3 cont., healthy, vigorous, well-rooted & established in container
#3 cont., healthy, vigorous, well-rooted & established in container
#3 cont., healthy vigorous, well-rooted & established in container
#5 cont., healthy, vigorous, well-rooted & established in container

REMARKS 12" o.c., full specimen, healthy, vigorous, well-rooted and established  $8^{"}$  o.c., full specimen, healthy, vigorous, well-rooted and established

REMARKS 15" o.c., full specimen, healthy, vigorous, well-rooted and established 16" o.c., full specimen, healthy, vigorous, well-rooted and established 30" o.c., full specimen, healthy, vigorous, well-rooted and established 24" o.c., full specimen, healthy, vigorous, well-rooted and established 18" o.c., full specimen, healthy, vigorous, well-rooted and established

	THE FLATS AT KNOWLES STATION 10509 SUMMIT AVENUE KENSINGTON, MARYLAND
	CLIENT 4000 KNOWLES VENTURE, LLC C/O WOODSIDE VENTURES & REALITY SERVICES
	Studiogeneration Structure and Scape Architecture, p.c. 6416 GROVEDALE DR., SUITE 100-A ALEXANDRIA, VIRGINIA 22310 703.719.6500   STUDIO39.COM
	seal/signature
	ISSUE DATE
	THIS DOCUMENT , AND THE IDEAS AND DESIGNS INCORPORATED HEREIN AS AN INSTRUMENT OF PROFESSIONAL SERVICE, IS THE PROPERTY OF STUDIO39 LANDSCAPE ARCHITECTURE, P.C. AND IS NOT TO BE COPIED AND/OR USED, IN WHOLE OR IN PART FOR ANY NOT TO BE COPIED AND/OR USED, IN WHOLE OR IN PART FOR ANY
	OTHER PROJECT WITHOUT THE WRITTEN AUTHORIZATION OF STUDIO39 LANDSCAPE ARCHITECTURE, P.C. © STUDIO39 LANDSCAPE ARCHITECTURE, P.C. PROJECT NUMBER: 20005 CONTACT: DAVID JUDD DRAWN: YJ APPROVED/CHECKED: DJ
	ORIENTATION AND SCALE N SCALE: 1"=0'-0"
	O       1       1       2         SHEET TITLE       PLANTING
%%	SCHEDULE SHEET NUMBER
8	L3.10

		0 1
Developer's Certificate The Undersigned agrees to execute all the features of the Site Plan A including Approval Conditions, Development Program, and Certified S 10509 SUMMIT VENTURE, LLC Developer: C/O WOODSIDE VENTURES & REALTY SERVCES	pproval No. <u>820210030</u> ite Plan. THOMAS BRAUL <b>T</b>	SHEET TITLE PLANTING SCHEDULE
Company	Contact Person	65
Address: 7215 RIDGEWOOD TERRACE, CHEVY CHASE, MD 208	15	SHEET NUMBE
Phone: 703-868-2832		
		LJ.
Signature:		SITE PLAN

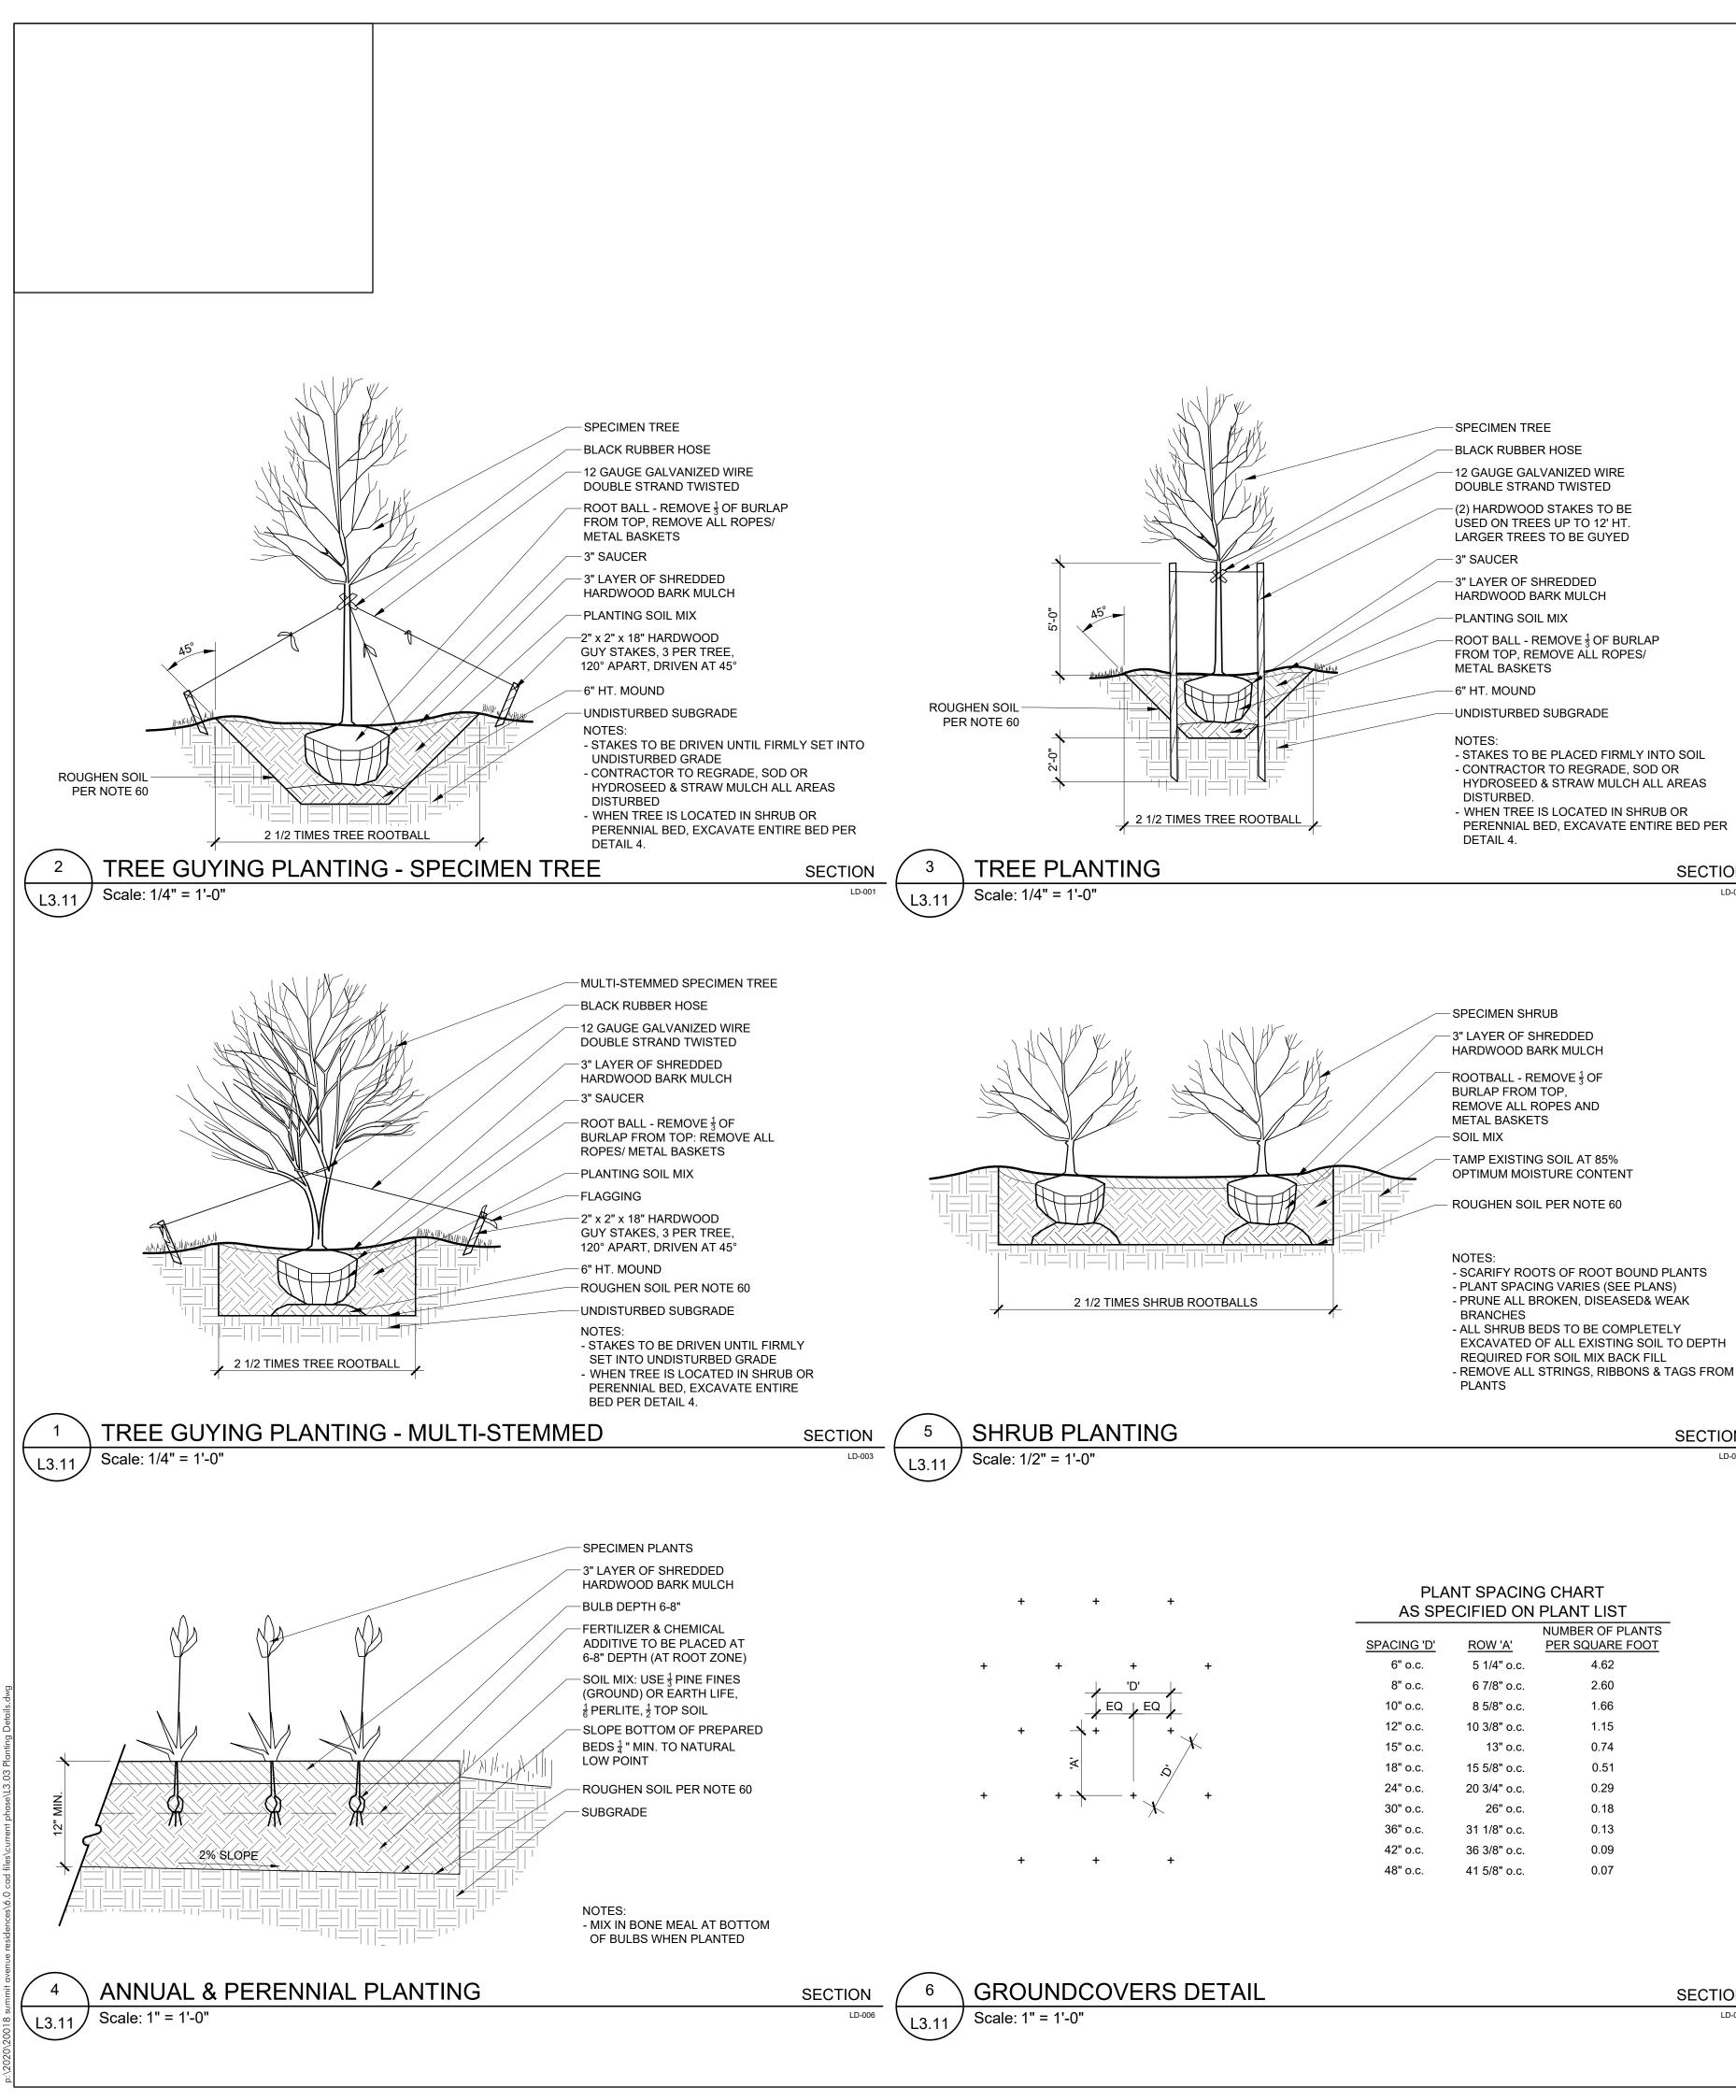

### PLANT SPACING CHART AS SPECIFIED ON PLANT LIST NUMBER OF PLANTS

		NUMBER OF PLANTS
SPACING 'D'	<u>ROW 'A'</u>	PER SQUARE FOOT
6" o.c.	5 1/4" o.c.	4.62
8" o.c.	6 7/8" o.c.	2.60
10" o.c.	8 5/8" o.c.	1.66
12" o.c.	10 3/8" o.c.	1.15
15" o.c.	13" o.c.	0.74
18" o.c.	15 5/8" o.c.	0.51
24" o.c.	20 3/4" o.c.	0.29
30" o.c.	26" o.c.	0.18
36" o.c.	31 1/8" o.c.	0.13
42" o.c.	36 3/8" o.c.	0.09
48" o.c.	41 5/8" o.c.	0.07

- SPECIMEN TREE -BLACK RUBBER HOSE
- **12 GAUGE GALVANIZED WIRE**
- DOUBLE STRAND TWISTED - (2) HARDWOOD STAKES TO BE **USED ON TREES UP TO 12' HT**
- LARGER TREES TO BE GUYED - 3" SAUCER
- 3" LAYER OF SHREDDED HARDWOOD BARK MULCH
- PLANTING SOIL MIX -ROOT BALL - REMOVE <sup>1</sup>/<sub>3</sub> OF BURLAP FROM TOP, REMOVE ALL ROPES/
- METAL BASKETS
- -6" HT. MOUND
- -UNDISTURBED SUBGRADE

### NOTES:

- STAKES TO BE PLACED FIRMLY INTO SOIL - CONTRACTOR TO REGRADE, SOD OR HYDROSEED & STRAW MULCH ALL AREAS DISTURBED.
- WHEN TREE IS LOCATED IN SHRUB OR PERENNIAL BED, EXCAVATE ENTIRE BED PER DETAIL 4.

SECTION

SECTION

SECTION

LD-004

LD-002

- SYSTEMS.
- EXISTING TREE AREAS.
- CONTRACTOR'S LIABILITY TO RELOCATE MATERIALS.
- GRADED SO AS TO NOT IMPEDE DRAINAGE AWAY FROM BUILDINGS. PERIOD.
- REBUILDING SPECIFICATIONS)
- CONTRACTOR TO SUBMIT SAMPLE FOR APPROVAL PRIOR TO INSTALLATION. 38. CROWN OF ROOT BALL SHALL BE HIGHER (AFTER SETTLING) THAN ADJACENT SOIL.
- 40. SHRUBS AND GROUND COVERS SHALL BE TRIANGULARLY SPACED AT SPACING SHOWN ON PLANTING PLANS.
- INCLUDE ANY TERMINAL GROWTH.
- CONTRACTOR FAILS TO SUBMIT A WRITTEN REQUEST, IT WILL RESULT IN LIABILITY TO THE CONTRACTOR.
- CURB, GUTTERS AND SIDEWALKS DAILY DURING INSTALLATION.
- TOPSOIL AND OTHER SOIL ADDITIVES ARE REQUIRED. (REFER TO SOIL PROFILE REBUILDING SPECIFICATIONS)
- 47. CONTRACTOR SHALL BE RESPONSIBLE TO RE-GRADE, SEED, STRAW MULCH, AND TACK ALL LAWN AREAS DISTURBED AS THE RESULT OF HIS WORK.
- 48. ALL EXISTING SOIL TO BE REMOVED FROM PERENNIAL BEDS TO A DEPTH OF 12" AND REPLACED WITH SOIL MIX PER DETAIL.
- PLANTS DURING THE FOLLOWING RECOMMENDED PLANTING SEASON.
- CURRENT EDITION, UNLESS OTHERWISE NOTED ON THESE PLANS. 51. ALL PLANTING SHALL CONFORM TO THE REQUIREMENTS OF MARYLAND DEPARTMENT OF HIGHWAYS AND TRANSPORTATION'S "GUIDELINES FOR PLANTING ALONG MARYLAND'S ROADWAYS."
- UTILITY LINES, AND THEIR ASSOCIATED EASEMENTS.
- REQUIRED UNDER MARYLAND REGULATIONS.

- PLANTING NOTES
- 2. THE CONTRACTOR SHALL BE RESPONSIBLE FOR PLANTING AT CORRECT GRADES AND ALIGNMENT. LAYOUT TO BE APPROVED BY OWNERS' REPRESENTATIVE PRIOR TO INSTALLATION.
- AND BE FREE FROM DEFECTS AND INJURIES.
- SUCCEEDING PLANTING SEASON. ALL REPLACEMENTS SHALL HAVE A GUARANTEE EQUAL TO THAT STATED ABOVE 6. PLANT MATERIAL SHALL BE PLANTED ON THE DAY OF DELIVERY IF/WHEN PRACTICAL. IN THE EVENT THAT THIS IS NOT POSSIBLE, THE CONTRACTOR SHALL PROTECT STOCK NOT
- REJECTED, UNLESS OWNER AND CONTRACTOR PROVIDE OTHERWISE BY WRITTEN AGREEMENT. NURSERY STOCK" PUBLISHED BY THE AMERICAN ASSOCIATION OF NURSERYMEN, INC.
- 9. PLANTS SHALL NOT BE BOUND WITH WIRE OR ROPE AT ANY TIME SO AS TO DAMAGE THE BARK OR BREAK BRANCHES. PLANTS SHALL BE HANDLED FORM THE BOTTOM OF THE
- BALL ONLY. "WILT-PRUF" OR EQUAL AS PER MANUFACTURER'S INSTRUCTIONS. 11. NO PLANT, EXCEPT GROUND COVERS, SHALL BE PLANTED LESS THAN TWO FEET FROM EXISTING STRUCTURES AND SIDEWALKS.
- ESTABLISHED. LOCATE THE PLANT IN THE CENTER OF THE PIT. 13. ALL INJURED ROOTS SHALL BE PRUNED TO MAKE CLEAN ENDS BEFORE PLANTING UTILIZING CLEAN, SHARP TOOLS. IT IS ADVISABLE TO PRUNE APPROXIMATELY 1/3 OF THE
- OF TREES SHALL NOT BE CUT BACK. LONG SIDES BRANCHES SHALL BE SHORTENED DONE WITH CLEAN, SHARP TOOLS,
- GUARANTEE PERIOD.
- 16. ALL PLANTING BEDS SHALL BE MULCHED WITH 2" LAYER OF PINE FINES MULCH. 17. NEW PLANTING AREAS AND SOD SHALL BE ADEQUATELY WATERED TO ESTABLISH THE PROPOSED PLANTS AND LAWN.
- APPROPRIATE SEASON.
- EROSION AND SEDIMENT CONTROL SHEET. (REFER TO SOIL PROFILE REBUILDING SPECIFICATIONS) CONDITION THROUGHOUT THE ONE-YEAR GUARANTEE PERIOD, UNLESS OTHERWISE SPECIFIED.
- 21. ALL DIMENSIONS TO BE TAKEN FROM BACK OF CURB.
- 22. CONTRACTOR SHALL LAYOUT AND CLEARLY STAKE ALL PROPOSED IMPROVEMENTS INCLUDED ON THIS PLAN.
- TO FINAL BID NEGOTIATION. UNIT PRICES FOR ALL MATERIAL SHALL BE SUPPLIED TO THE OWNER AT BIDDING TIME.
- UPON THE APPROVAL OF THE LANDSCAPE ARCHITECT.
- 26. WHERE TREES ARE PLANTED IN ROWS, THEY SHALL BE UNIFORM IN SIZE AND SHAPE. OF THAT PLANT

# HAVE TOPS WHICH ARE GOOD QUALITY AND ARE IN A HEALTHY GROWING CONDITION.

1. PLANT MATERIAL SHALL BE FURNISHED AND INSTALLED AS INDICATED, INCLUDING ALL LABOR, MATERIALS, PLANTS, EQUIPMENT, INCIDENTALS, AND CLEAN-UP.

3. PLANTS SHALL BE TYPICAL OF THEIR SPECIES AND VARIETY: HAVE NORMAL GROWTH HABITS, WELL-DEVELOPED DENSELY FOLIATED BRANCHES, AND VIGOROUS ROOT SYSTEMS:

4. CONTRACTOR SHALL REPORT ANY SOIL OR DRAINAGE CONDITIONS CONSIDERED DETRIMENTAL TO GROWTH OF PLANT MATERIAL 5. ALL PLANT MATERIAL SHALL BE GUARANTEED BY THE CONTRACTOR TO BE IN VIGOROUS GROWING CONDITION. PROVISION SHALL BE MADE FOR A GROWTH GUARANTEE OF AT LEAST ONE YEAR FROM THE DATE OF ACCEPTANCE FOR TREES, SHRUBS, GROUNDCOVER AND PERENNIALS. REPLACEMENTS SHALL BE MADE AT THE BEGINNING OF THE FIRST

PLANTED. PLANTS SHALL NOT REMAIN UNPLANTED FOR LONGER THAN A THREE-DAY PERIOD AFTER DELIVERY. ANY PLANTS NOT INSTALLED DURING THIS PERIOD SHALL BE 7. QUALITY AND SIZE OF PLANTS, SPREAD OF ROOTS, AND SIZE OF ROOT BALL SHALL BE IN ACCORDANCE WITH THE MOST RECENT VERSION OF ANSI Z60 "AMERICAN STANDARD FOR

8. ALL PLANTS SHALL BE PLANTED IN AMENDED TOP SOIL THAT IS THOROUGHLY WATERED AND TAMPED AS BACK-FILLING PROCESSES. PLANTING MIX TO BE AS SHOWN ON PLANTING DETAILS. LARGE PLANTING AREAS TO INCORPORATE FERTILIZER AND SOIL CONDITIONERS AS STATED IN PLANTING SPECIFICATIONS.

10. PLANTING OPERATIONS SHALL BE PERFORMED DURING PERIODS WITHIN THE PLANTING SEASON WHEN WEATHER AND SOIL CONDITIONS ARE SUITABLE AND IN ACCORDANCE. WITH ACCEPTED LOCAL PRACTICE. PLANTS SHALL NOT BE INSTALLED IN TOP SOIL THAT IS IN A MUDDY OR FROZEN CONDITION. ALL PLANT MATERIAL SHALL BE SPRAYED WITH

12. SET ALL PLANTS PLUMB AND STRAIGHT. SET AT SUCH LEVEL THAT A NORMAL OR NATURAL RELATIONSHIP TO THE GROUND IF THE PLANT WITH THE GROUND SURFACE WILL BE

GROWTH OF LARGE TREES (2" CALIPER AND GREATER) BY THE REMOVAL OF SUPERFLUOUS BRANCHES, THOSE WHICH CROSS, THOSE WHICH RUN PARALLEL, ETC. MAIN LEADER 14. EACH TREE AND SHRUB SHALL BE PRUNED IN ACCORDANCE WITH STANDARD HORTICULTURAL PRACTICE TO PRESERVE THE NATURAL CHARACTER OF PLANT. PRUNING SHALL BE

15. TREES SHALL BE SUPPORTED IMMEDIATELY AFTER PLANTING. ALL TREES 6" AND GREATER IN CALIPER SHALL BE GUYED. SMALLER TREES SHALL BE STAKED. GUYING WIRES AND STAKES SHALL BE INSTALLED AS INDICATED. THE LANDSCAPE CONTRACTOR SHALL REMOVE STAKING, GUYING AND TREE WRAP AT THE END OF ONE YEAR MAINTENANCE AND

18. ALL PLANTS SHOWN ON THE APPROVED LANDSCAPE PLAN SHALL BE INSTALLED, INSPECTED AND APPROVED BY THE LANDSCAPE ARCHITECT OR HIS REPRESENTATIVE. THE LANDSCAPE ARCHITECT SHALL TAKE INTO ACCOUNT SEASONAL CONSIDERATIONS IN THIS REGARD. TREES, SHRUBS, VINES AND GROUNDCOVER AS REQUIRED BY OR ASSOCIATED WITH A SUBDIVISION OR SITE PLAN APPROVED BY THE PLANNING AUTHORITIES SHALL BE INSTALLED DURING THE FOLLOWING PLANTING SEASONS: LAWNS: 03/15 TO 06/15 AND 09/15 TO 12/01. THE FOLLOWING TREE VARIETIES SHALL NOT BE PLANTED DURING THE FALL PLANTING SEASON DUE TO THE HAZARDS ASSOCIATED WITH PLANTING THESE TREES IN THIS SEASON: ACER RUBRUM POPULUS SPP.; BETULA SPP. PRUNUS SPP.; CARPINUS SPP. PYRUS SPP.; CRATECUS SPP. QUERCUS SPP.; KOELREUTERIA PANICULATA SALIX SPP.; LIQUIDAMBAR STYRACIFLUA TILIA TOMENTOSA; LIRIODENDRON TULIPIFERA ZELKOVA; PLATANUS ACERIFOLIA; ANY PLANTING INSTALLED IN CONFLICT WITH THIS REQUIREMENT MUST RECEIVE WRITTEN APPROVAL OF THE LANDSCAPE ARCHITECT PRIOR TO PLANTING. FAILURE TO COMPLY WITH THESE REQUIREMENTS WILL REQUIRE THE REMOVAL OF THE PLANTING IN QUESTION. THIS REQUIREMENT DOES NOT APPLY TO SEEDING OR SODDING OR PLANTINGS SPECIFICALLY FOR SOIL STABILIZATION PURPOSES. PLANTINGS ASSOCIATED WITH ANY LOT GIVEN A CERTIFICATE OF OCCUPANCY OUTSIDE THESE PERIODS SHALL BE PROVIDED DURING THE PREVIOUS OR NEXT

19. ALL DISTURBED AREAS SHALL BE TREATED WITH 4" TOP SOIL SODDED OR SEEDED AS NOTED IN ACCORDANCE WITH PERMANENT STABILIZATION METHODS INDICATED ON SOIL 20. CONTRACTOR SHALL BE SOLELY RESPONSIBLE FOR ALL PLANT MAINTENANCE; INCLUDING SHRUBS AND GROUNDCOVER, AND SHALL MAINTAIN AREA IN A WEED AND DEBRIS FREE

23. CONTRACTOR IS RESPONSIBLE FOR CONTACTING UTILITY COMPANY PRIOR TO BEGINNING CONSTRUCTION FOR LOCATION OF ALL UTILITY LINES. TREES SHALL BE LOCATED A MINIMUM OF 5' FROM SEWER/WATER CONNECTIONS. CONTRACTOR SHALL BE LIABLE FOR DAMAGE TO ANY AND ALL PUBLIC OR PRIVATE UTILITIES. ALL THE CREDITED MITIGATION PLANTINGS WILL BE AT LEAST 5 FEET AWAY FROM ANY STRUCTURES, SWM FACILITIES, UTILITY LINES, AND THEIR ASSOCIATED EASEMENTS. 24. CONTRACTOR TO VERIFY PLANT LIST TOTALS WITH QUANTITIES SHOWN ON PLAN. LANDSCAPE ARCHITECT SHALL BE ALERTED BY CONTRACTOR OF ANY DISCREPANCIES PRIOR

25. ALL MATERIALS SHALL BE SUBJECT TO APPROVAL BY THE LANDSCAPE ARCHITECT. OWNER SHALL RECEIVE TAG FROM EACH PLANT SPECIES AND A LIST OF PLANT SUPPLIERS. WHERE ANY REQUIREMENTS ARE OMITTED FROM THE PLANT LIST. THE PLANTS FURNISHED SHALL MEET THE NORMAL REQUIREMENTS FOR THE VARIETY PER THE AMERICAN STANDARD FOR NURSERY STOCK, LATEST EDITION, PUBLISHED BY THE AMERICAN ASSOCIATION OF NURSERYMEN (AAN). PLANTS SHALL BE PRUNED PRIOR TO DELIVERY ONLY

27. SIZES SPECIFIED IN THE PLANT LIST ARE MINIMUM SIZES TO WHICH THE PLANTS ARE TO BE JUDGED. FAILURE TO MEET MINIMUM SIZE ON ANY PLANT WILL RESULT IN REJECTION

28. ALL PLANTS SHALL BE FRESHLY DUG, SOUND, HEALTHY, VIGOROUS, WELL BRANCHED, FREE OF DISEASE, INSECT EGGS, AND LARVAE, AND SHALL HAVE ADEQUATE ROOT

29. ALL CONTAINER GROWN MATERIAL SHALL BE HEALTHY, VIGOROUS, WELL-ROOTED PLANTS AND ESTABLISHED IN THE CONTAINER IN WHICH THEY ARE SOLD. THE PLANTS SHALL 30. UNLESS SHOWN OTHERWISE ON PLANS, GROUPS OF SHRUBS SHALL BE PLACED IN A CONTINUOUS MULCH BED WITH SMOOTH CONTINUOUS LINES. ALL MULCHED BED EDGES

SHALL BE CURVILINEAR IN SHAPE FOLLOWING THE CONTOUR OF THE PLANT MASS. TREES LOCATED WITHIN FOUR FEET OF SHRUB BEDS SHALL SHARE SAME MULCH BED. 31.NO EXISTING TREES SHALL BE REMOVED WITHOUT WRITTEN AUTHORIZATION FROM THE OWNER EXCEPT WHERE NOTED ON PLANS. NO GRUBBING SHALL OCCUR WITHIN

32. TREES SHALL BE LOCATED A MINIMUM OF 3' - 4' FROM WALLS AND WALKS WITHIN THE PROJECT. IF CONFLICTS ARISE BETWEEN ACTUAL SIZE OF AREA AND PLANS, CONTRACTOR SHALL CONTACT LANDSCAPE ARCHITECT FOR RESOLUTION. FAILURE TO MAKE SUCH CONFLICTS KNOWN TO THE OWNER OR LANDSCAPE ARCHITECT WILL RESULT IN

33. UNLESS SHOWN OTHERWISE ON PLANS, LARGE GROWING PLANTS ARE NOT TO BE PLANTED IN FRONT OF WINDOWS, UNDER BUILDING OVERHANGS, OR IN DRAINAGE SWALES. SHRUBS PLANTED NEAR H.V.A.C. UNITS TO BE LOCATED SO THAT SHRUBS AT MATURITY WILL MAINTAIN 1' AIRSPACE BETWEEN UNIT AND PLANT. 34. CONTRACTOR TO SLIGHTLY ADJUST PLANT LOCATIONS IN THE FIELD AS NECESSARY TO BE CLEAR OF DRAINAGE SWALES AND UTILITIES. FINISHED PLANTING BEDS SHALL BE

35. TREE STAKING AND GUYING SHALL BE DONE PER DETAILS. CONTRACTOR SHALL ENSURE THAT TREES REMAIN VERTICAL AND UPRIGHT FOR THE DURATION OF THE GUARANTEE

36. ALL TREE PITS, SHRUB BEDS AND PREPARED PLANTING BEDS ARE TO BE COMPLETELY EXCAVATED IN ACCORDANCE WITH THE PLANTING DETAILS. (REFER TO SOIL PROFILE

37. MULCH IS TO BE FINE BARK TYPE FOR TREES AND SHRUBS. FINE BARK MULCH IS TO BE USED FOR PERENNIAL BEDS AND WITHIN THE "EXISTING TREES TO REMAIN."

39. TAGS AND TWINE ARE TO BE REMOVED AND BURLAP IS TO BE ROLLED BACK ONE-THIRD ON ALL B&B PLANT MATERIAL. REMOVE BURLAP IF IT IS NON-BIODEGRADABLE. FOR STREET TREES TAGS. TWINE, CORD, BURLAP AND WIRE BASKET TO BE CUT 12" DOWN SIDE OF ROOT BALL AND REMOVED FROM PROJECT SITE.

41. SHADE TREES: HEIGHT SHALL BE MEASURED FROM THE CROWN OF THE ROOT BALL TO THE TOP OF MATURE GROWTH. SPREAD SHALL BE MEASURED TO THE END OF BRANCHING EQUALLY AROUND THE CROWN FROM THE CENTER OF THE TRUNK. MEASUREMENTS ARE NOT TO INCLUDE ANY TERMINAL GROWTH. SINGLE TRUNK TREES SHALL BE FREE OF "V" CROTCHES THAT COULD BE POINTS OF WEAK LIMB STRUCTURE OR DISEASE INFESTATION. SHRUBS: HEIGHT SHALL BE MEASURED FROM THE GROUND TO THE AVERAGE HEIGHT OF THE TOP OF THE PLANT. SPREAD SHALL BE MEASURED TO THE END OF BRANCHING EQUALLY AROUND THE SHRUB MASS. MEASUREMENTS ARE NOT TO

42. ALL SUBSTITUTIONS OF PLANT MATERIAL ARE TO BE REQUESTED IN WRITING TO THE LANDSCAPE ARCHITECT AND APPROVED BY THE OWNER AND MNCPPC PLANNING STAFF. IF 43. ALL CONTRACTORS SHALL BE REQUIRED TO COMPLETELY REMOVE ALL TRASH, DEBRIS AND EXCESS MATERIALS FROM THE WORK AREA AND THE PROPERTY, ESPECIALLY AT ALL

44. DEAD PLANTS ARE TO BE REMOVED FROM THE JOB BY THE CONTRACTOR WEEKLY. CONTRACTOR SHALL MAINTAIN AN UPDATED, COMPREHENSIVE LIST OF ALL DEAD MATERIALS

REMOVED FROM THE JOB SITE. A COPY OF THE LIST IS TO BE SUBMITTED TO THE OWNER AT THE END OF EVERY MONTH DURING THE CONTRACT PERIOD. 45. TOPSOIL REQUIRED FOR SOIL MIXES AND SPECIAL SEEDING AREAS SHALL BE PROVIDED BY LANDSCAPE CONTRACTOR. CONTRACTOR MUST LOAD, HAUL, MIX, AND SPREAD ALL

46. THE INTENT OF THE PROJECT IS TO HAVE NATURAL DRIFTS OF PERENNIALS IN PLANTING. KEEP SWEEPS OF SIMILAR BULBS/PERENNIALS IN SEPARATE GROUPS.

49. CONTRACTOR SHALL GUARANTEE ALL LANDSCAPE IMPROVEMENTS, INCLUDING SEEDING, FOR ONE FULL YEAR AS REQUIRED BY THE SPECIFICATIONS. CONTRACTOR MUST CONTACT THE OWNER AT LEAST TEN WORKING DAYS IN ADVANCE TO SCHEDULE ACCEPTANCE INSPECTION(S). CONTRACTOR MUST REPLACE ALL DEAD OR UNACCEPTABLE

50. THE SPECIFICATIONS FOR ALL WORK INCLUDED IN THIS CONTRACT SHALL BE LANDSCAPE SPECIFICATIONS GUIDELINES FOR BALTIMORE-WASHINGTON METROPOLITAN AREA,

52. ANY PLANTING WHICH IS SHOWN ADJACENT TO CONDENSER UNITS SHALL BE PLANTED AS REQUIRED TO SCREEN THE UNITS. SHOULD THE CONDENSER UNITS BE INSTALLED IN LOCATIONS DIFFERENT FROM THOSE SHOWN ON THE PLAN IT WILL BE THE CONTRACTOR'S RESPONSIBILITY TO INSTALL THE MATERIALS AROUND THE CONDENSERS AND TO ADJUST OTHER ADJACENT PLANTING ACCORDINGLY. ALL THE CREDITED MITIGATION PLANTINGS WILL BE AT LEAST 5 FEET AWAY FROM ANY STRUCTURES, SWM FACILITIES,

53. ALL PLANTING MATERIAL, INCLUDING TREES SHALL CONFORM TO THE STANDARDS OF THE AMERICAN ASSOCIATION OF NURSERYMEN AND SHALL PASS ANY INSPECTION

Developer's Certificate The Undersigned agrees to execute all the features of the Site Plan A including Approval Conditions, Development Program, and Certified S	SHEET TITLE PLANTING D	
10509 SUMMIT VENTURE, LLC Developer: C/O WOODSIDE VENTURES & REALTY SERVCES Company	THOMAS BRAULT Contact Person	0
Address: 7215 RIDGEWOOD TERRACE, CHEVY CHASE, MD 208	15	SHEET NUMBER
Phone: 703-868-2832		L3.
Signature:		SITE PLAN

THE FLATS AT **KNOWLES STATION** 

10509 SUMMIT AVENUE MONTGOMERY COUNTY

CLIENT

4000 KNOWLES VENTURE, LLC C/O WOODSIDE VENTURES & REALITY SERVICES



416 GROVEDALE DR., SUITE 100-A
ALEXANDRIA, VIRGINIA 22310
703.719.6500   STUDIO39.COM

SEAL/SIGNATURE




ISSUE DATE

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OTHER PROJECT WITHOUT THE WRITTEN AUTHORIZATION OF

PROJECT NUMBER:	20005
CONTACT:	DAVID JUDD
DRAWN:	YJ
APPROVED/CHECKED:	DJ

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ORIENTATION AND SCALE



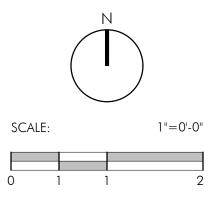

MANUFACTURER: DIMENSIONS: COLOR:

QUANTITY: NOTE:

BRICK PAVER

BELDEN

4" x 6" x 16"

LANDMARK GRAY

CHRIS MAYER POTOMAC VALLEY BRICK 703.550.9013 cmayer@pvbrick.com

PER PLAN

1) ALL CORNERS MUST BE FINGER JOINTED 2) CONTRACTOR TO VERIFY QUANTITIES. INSTALL PER MANUFACTURER'S RECOMMENDATION. AND GOVERNING MUNICIPAL REQ. OR APPROVED EQUAL



MODEL: DESCRIPTION: DIMENSIONS: OPTIONS: COLOR: QUANTITY: CONTACT: NOTES:

INVERTED 'U' BIKE RACK 24" L x 1.9" D x 35" H IN-GROUND MOUNT BLACK POWDERCOAT PER PLAN MANUFACTURER: DERO BIKE RACK CO. 2657 32ND AVE. S MINNEAPOLIS, MN 55406 www.dero.com MIKE ANDERSON 888.337.6729

HOOP RACK

- INSTALL PER MANUFACTURER'S RECOMMENDATIONS AND GOVERNING MUNICIPAL REQUIREMENTS. - CONTRACTOR TO VERIFY QUANTITIES. - OR APPROVED EQUAL.

PROD. INFO.

BIKE RACK 5

L4.01 Scale: N.T.S.



2

MODEL: MANUFACTURER: DIMENSIONS:

COLOR: CONTACT:

QUANTITY: NOTE:

BRICK PAVER BELDEN 4" x 8" x 16"

SIENNA BLEND VELOUR

CHRIS MAYER POTOMAC VALLEY BRICK 703.550.9013

cmayer@pvbrick.com PER PLAN

BRICK PAVER-SIENNA BLEND PROD. INFO.

1) ALL CORNERS MUST BE FINGER JOINTED 2) CONTRACTOR TO VERIFY QUANTITIES. INSTALL PER MANUFACTURER'S RECOMMENDATION. AND GOVERNING MUNICIPAL REQ. OR APPROVED EQUAL



Scale: N.T.S.

3

L4.01/

MODEL:

COMPANY:

COLOR:

VICTOR STANLEY BENCH

FINISH:

LIL 20CA-W1-474X332 LILY WITH CURVED ARMRESTS

TBD

PER PLAN QUANTITY:

> VICTOR STANLEY - US P.O. DRAWER 330 DUNKIRK, MD 20754 USA (P) 301.855.8300

CONTACT: TBD

1)INSTALL PER MANUFACTURER'S

PROD. INFO.

APPROVED EQUAL

**RECOMMENDATIONS OR** 



MODEL: FINISH: QUANTITY: COMPANY:

MONOLITH STONE BENCH TBD PER PLAN US STONE INDUSTRIES 73515 W 75TH ST #105 PRAIRIE VILLAGE, KS 66208


(P) 913-529-4154

CHRIS MAYER

CONTACT:

COLOR:

POTOMAC VALLEY BRICK 703.550.9013 CMAYER@PVBRICK.COM 1)INSTALL PER MANUFACTURER'S **RECOMMENDATIONS OR** APPROVED EQUAL

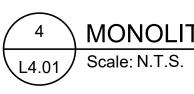

MONOLITH STONE BENCH

PROD. INFO.

# THE FLATS AT KNOWLES STATION

10509 SUMMIT AVENUE KENSINGTON, MARYLAND

### CLIENT 4000 KNOWLES VENTURE, LLC C/O WOODSIDE VENTURES & REALITY SERVICES STUDIO39 LANDSCAPE ARCHITECTURE, P.C 6416 GROVEDALE DR., SUITE 100-A ALEXANDRIA, VIRGINIA 22310

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seal/signature



ISSUE DATE

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PROJECT NUMBER: 20005 CONTACT: DAVID JUDD DRAWN: Y.J APPROVED/CHECKED: DJ


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ORIENTATION AND SCALE


# 1"=0'-0" SCALE: ) 1


L4.01


**Developer's Certificate** SHEET TITLE The Undersigned agrees to execute all the features of the Site Plan Approval No. 820210030 including Approval Conditions, Development Program, and Certified Site Plan. PRODUCT INFORMATION 10509 SUMMIT VENTURE, LLC Developer: C/O WOODSIDE VENTURES & REALTY SERVCES THOMAS BRAULT Contact Person Company Address: 7215 RIDGEWOOD TERRACE, CHEVY CHASE, MD 20815 Sheet NUMBER Phone: 703-868-2832 Signature: \_\_\_\_ SITE PLAN



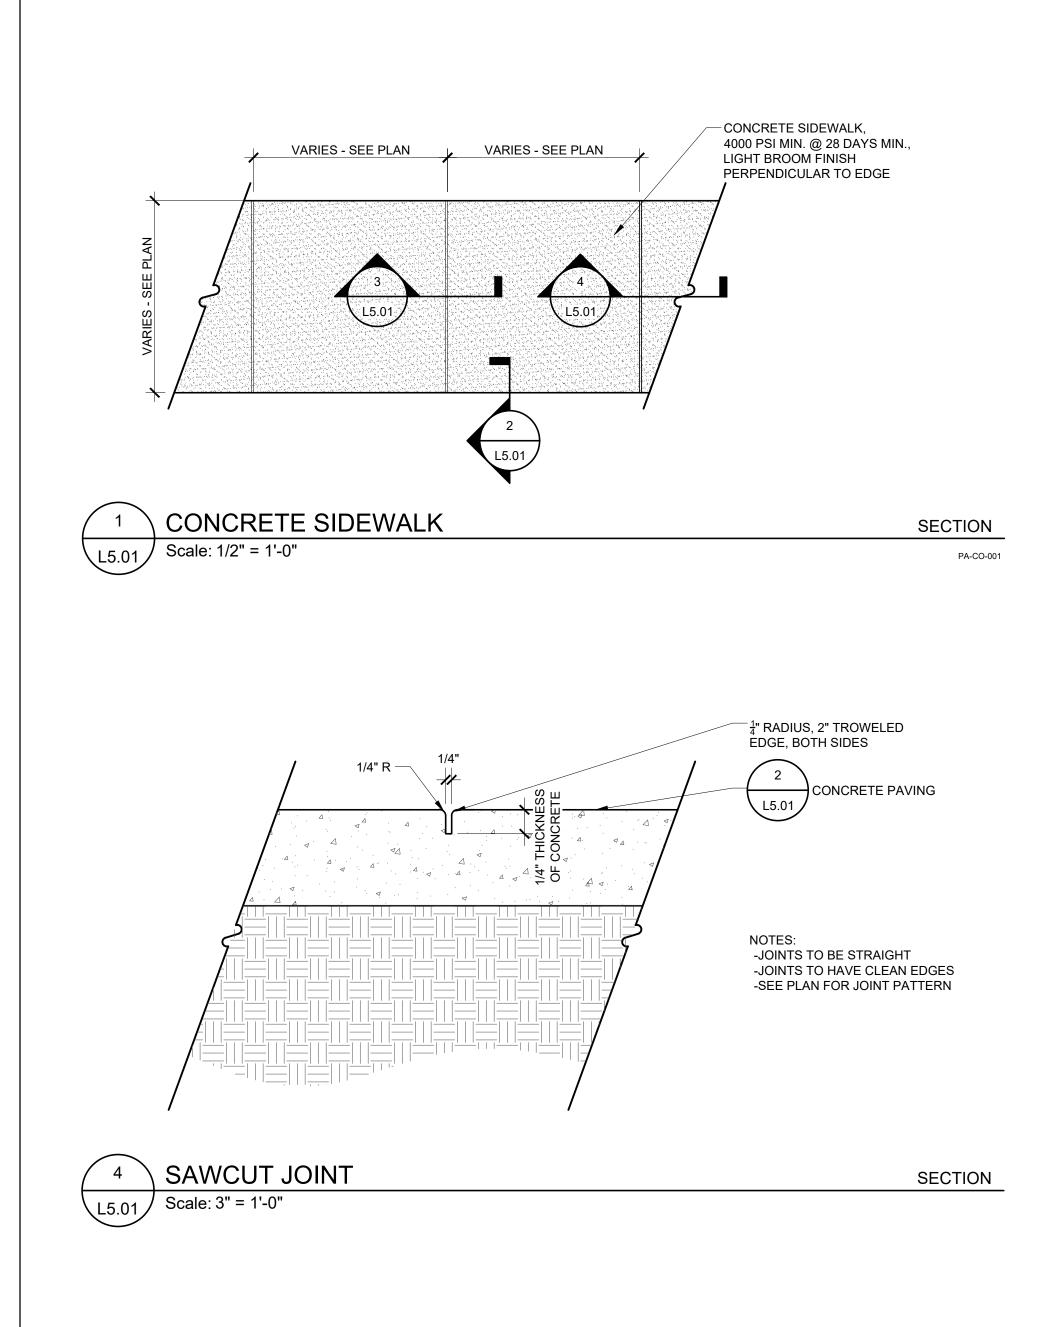

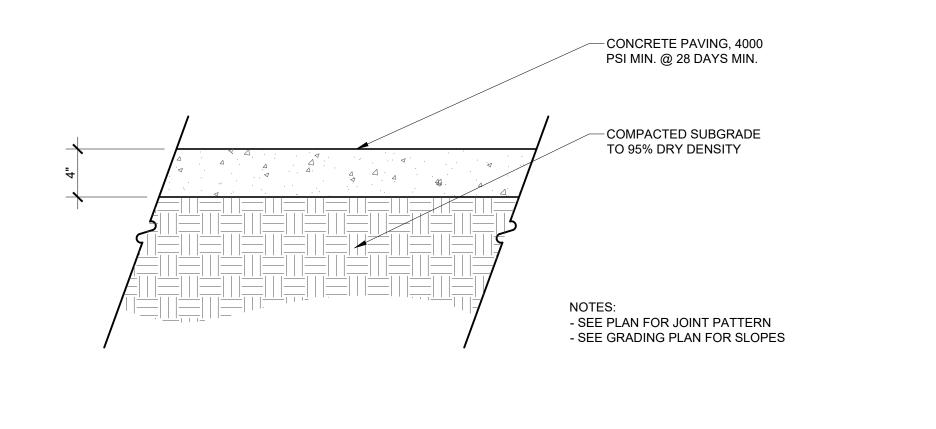

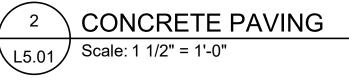

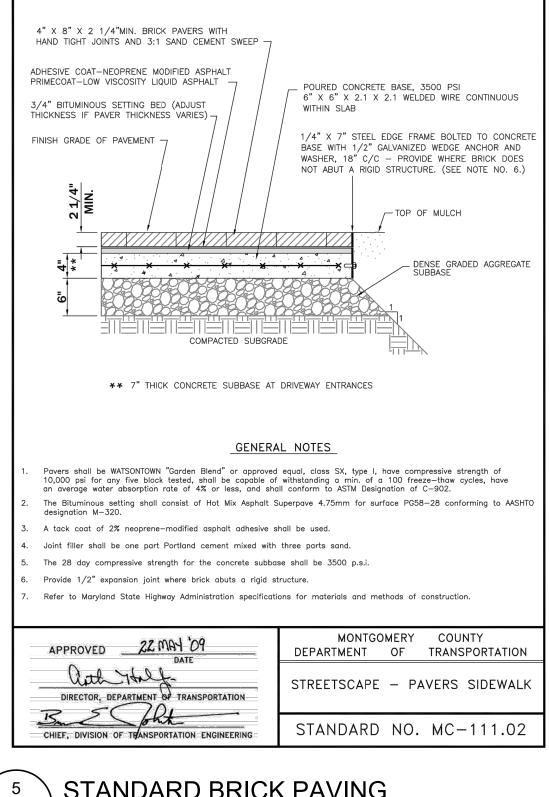

# STANDARD BRICK PAVING


SECTION

L5.01 Scale: NTS

SECTION

L5.01 Scale: 3" = 1'-0"

3

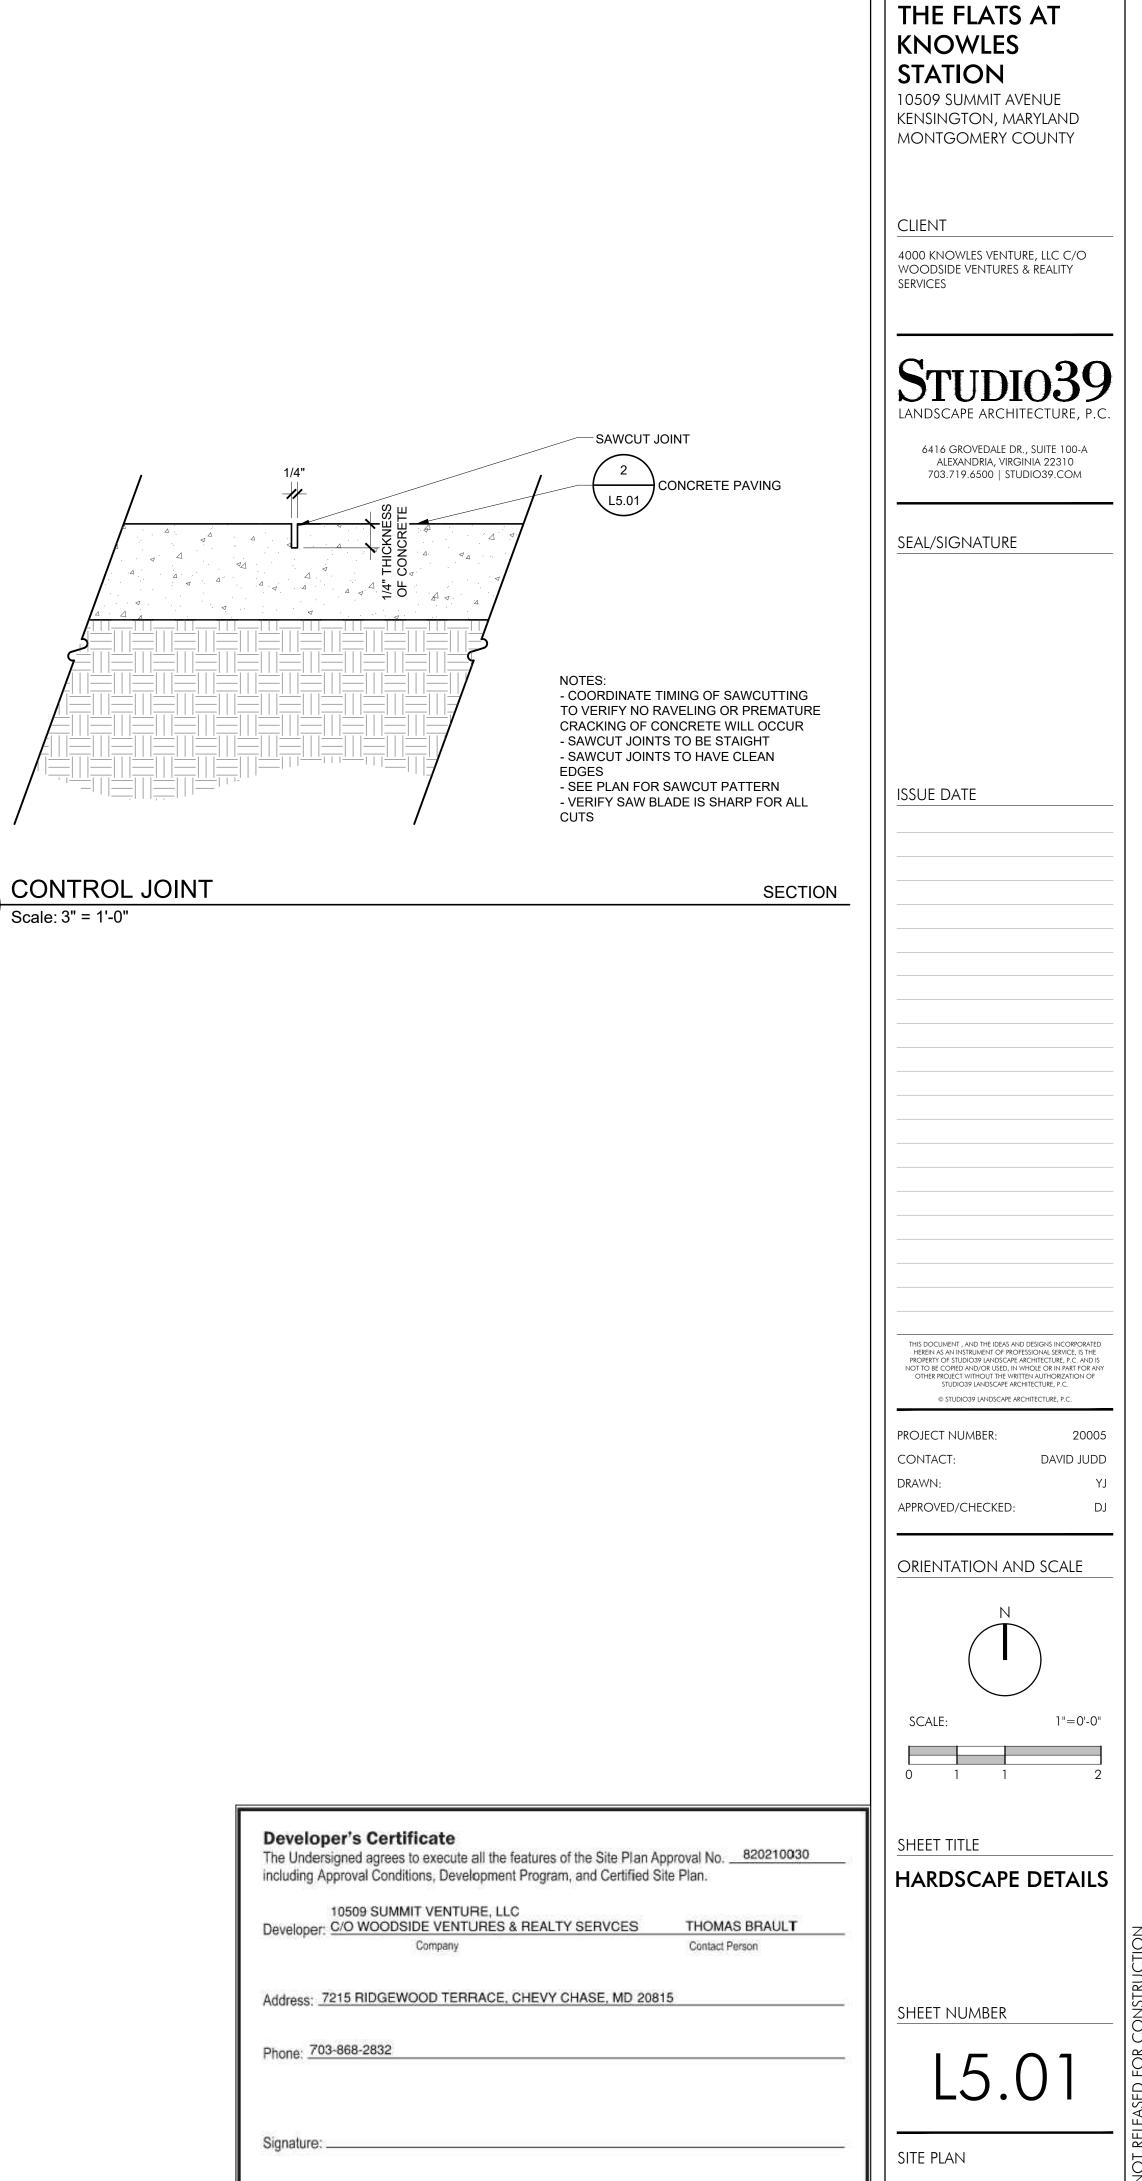



		THE FLATS AT KNOWLES STATION 10509 SUMMIT AVENUE KENSINGTON, MARYLAND
		CLIENT 4000 KNOWLES VENTURE, LLC C/O WOODSIDE VENTURES & REALITY SERVICES
		STUDIO39 LANDSCAPE ARCHITECTURE, P.C. 6416 GROVEDALE DR., SUITE 100-A ALEXANDRIA, VIRGINIA 22310 703.719.6500   STUDIO39.COM
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O REMAIN, TYP.	Strate and a strategy of the s	CONTACT: DAVID JUDD DRAWN: YJ APPROVED/CHECKED: DJ ORIENTATION AND SCALE
		N SCALE: 1"=10'-0"
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	Developer:       C/O WOODSIDE VENTURES & REALTY SERVCES       THOMAS BRAULT         Company       Contact Person         Address:       7215 RIDGEWOOD TERRACE, CHEVY CHASE, MD 20815         Phone:       703-868-2832	Sheet Number
PLAN	Signature:	<b>L6.00</b> SITE PLAN